



PLAN SCALE: 3/4"=1'-0"

NO. 8 D	OUBLE CROSSOVER END FROG, CENTER FROG - COMPLETE											
	BILL OF MATERIAL											
QUANTITY	QUANTITY DESCRIPTION — FURNISHED THIS CONTRACT											
2 EACH	MANGANESE STEEL INSERT END FROG WITH LEVEL GUARDS FOR 24'-02'-22" CROSSING ANGLE, COMPLETE (PER AREA STANDARD PLAN NO. 750-81 AND 761-83) AND MODIFIED AS INDICATED											
2 EACH	MANGANESE STEEL INSERT CENTER FROG WITH LEVEL GUARDS FOR 24"-02"-22" CROSSING ANGLE, COMPLETE (PER AREA STANDARD PLAN NO. 750-81 AND 761-83) AND MODIFIED AS INDICATED											
2 PER FROG	BONDED FROG INSERTS											
A.R.	GR PLATES											
48	BOLTLESS ADJUSTABLE BRACE WITH LEFT HAND PANDROL CLIPS e2056											

- 1. RAIL AND COMPONENTS SHALL CONFORM TO 115 RE RAIL SECTION.
- RAIL DRILLINGS, BAR PUNCHINGS, OVAL NECK TRACK BOLTS AND TRACK BOLT NUTS SHALL BE IN ACCORDANCE WITH AREMA MANUAL, VOL. 1, PAGES 4-1-13 THRU 4-1-18 (36"-6 HOLE JOINT BAR, 115 RE RAIL SECTION).
- CROSSOVER END AND CENTER FROGS SHALL BE RAILBOUND MAGANESE STEEL EXPLOSION HARDENED PER TRACKWORK SPECIFICATIONS.
- 4. ALL SPECIAL FROG PLATES SHALL BE 3/4" THICK WITH NO RAIL CANT.
- 5. ELASTOMER PADS SHALL BE 3/4" THICK AND EXTEND BEYOND THE FROG PLATES 1" ON ALL SIDES.
- 6. THE BONDED FROG AND BONDED CENTER FROG INSERTS SHALL BE MILLED CARBON STEEL CASTINGS AS SPECIFIED IN THE CONTRACT SPECIFICATIONS AND AS SHOWN ON THIS DRAWING.

	REFERENCE DRAWINGS REVISIONS						REVISIONS	WASHINGTON METROPOLITAN AREA TRANSIT AUTHORITY TRACKWORK PROCUREMENT
DESIGNED			-	NUMBER DESCRIPTION	DATE	BY	DESCRIPTION	NO. 8 GUARDED DOUBLE CROSSOVER, DIAMON
DRAMN _	CR	CCHS 4	<u>/06</u>					OFFICE OF ENGINEERING SUPPORT SERVICES PLATE, 40'-6" TRACK CENTERS,
CHECKED .	RR	EYES 4	/05		- 1	N N		DETAIL O DIDECT CIVATION
APPROVED.	LP	ADGETT 4	/06					SUBMITTED -URPACISETY 10/2007 APTROVED 10/2007 SCALE DRAWING NO.
Department of the Control of the		1/2						DATE DATE AS SHOWN DD-TW-073

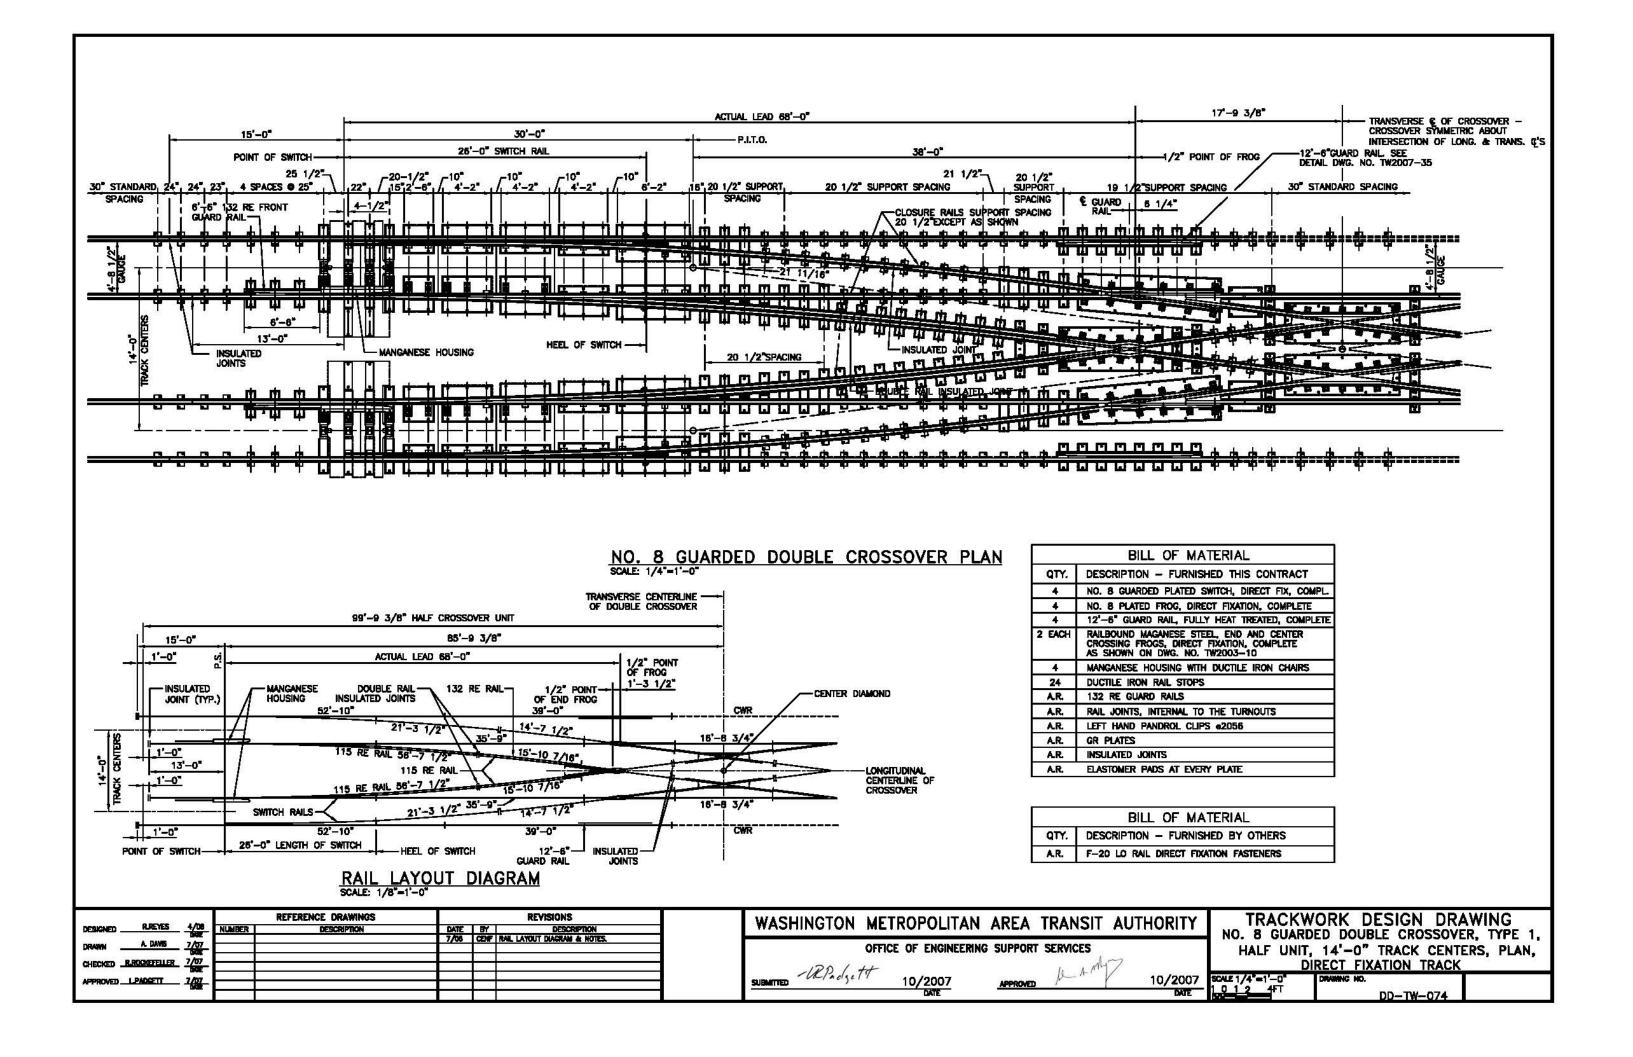

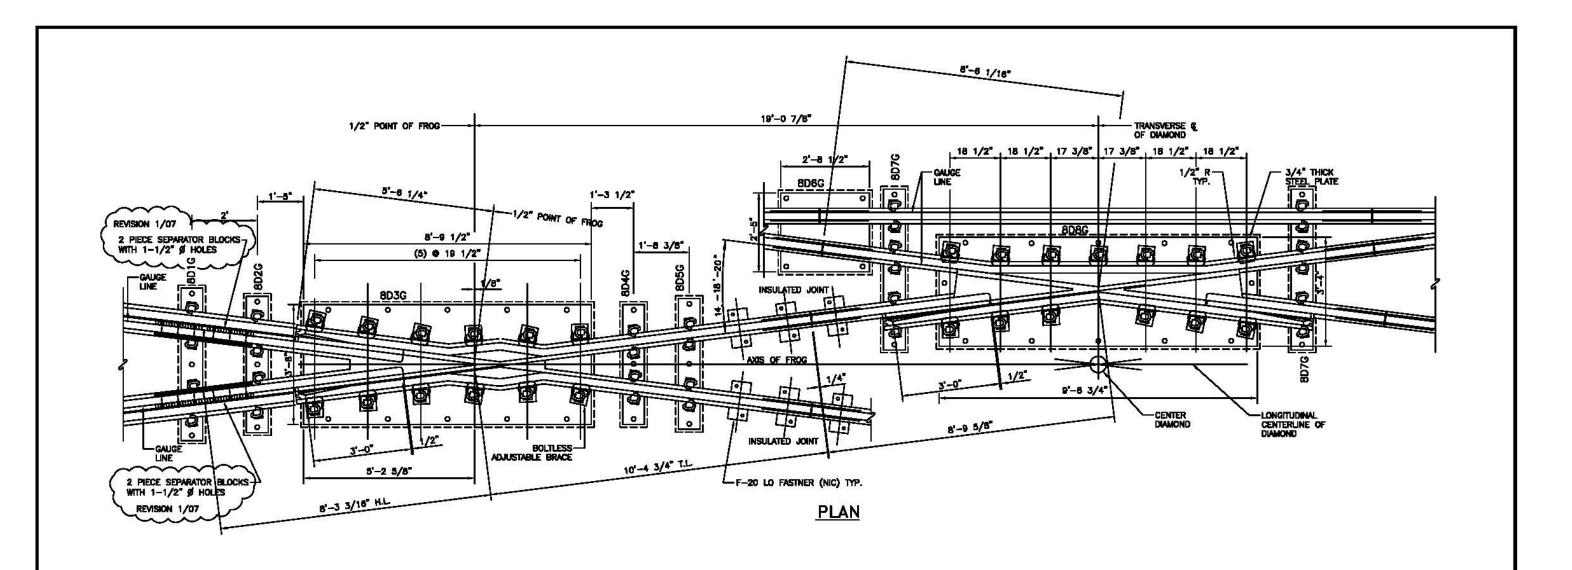



NO. 8 DO	UBLE CROSSOVER CENTER FROG & END FROG - COMPLETE
	BILL OF MATERIAL
QUANTITY	DESCRIPTION - FURNISHED THIS CONTRACT
2 EACH	MANGANESE STEEL INSERT END FROG WITH LEVEL GUARDS FOR 14"-18"-20" CROSSING ANGLE, COMPLETE (PER AREMA STANDARD PLAN NO. 750-81 AND 761-83) AND MODIFIED AS INDICATED
2 EACH	MANGANESE STEEL INSERT CENTER FROG WITH LEVEL GUARDS FOR 14"-18"-20' CROSSING ANGLE, COMPLETE (PER AREMA STANDARD PLAN NO. 750-81 AND 761-83)
2 EACH	SPECIAL PLATES 8D1 THRU 8D5, COMPLETE
2 PER FROG	BONDED FROG INSERTS
48	BOLTLESS ADJUSTABLE BRACE WITH LEFT HAND PANDROL CLIPS #2056


F	LATE DETAILS	S
PLATE	LENGTH	WIDTH
8D1G	4'-8"	8"
8D2G	4'-2"	8*
8D4G	3'-8"	8"
8D5G	4'-0"	8*
8D7G	4'-11"	8*


- 1. RAIL AND COMPONENTS SHALL CONFORM TO 115 RE RAIL SECTION.
- 2. RAIL DRILLINGS, BAR PUNCHINGS, OVAL NECK TRACK BOLTS AND TRACK BOLT NUTS SHALL BE IN ACCORDANCE WITH AREMA MANUAL, VOL. 1, PAGES 4-1-13 THRU 4-1-18 (36"-6 HOLE JOINT BAR, 115 RE RAIL SECTION).
- CROSSOVER END AND CENTER FROGS SHALL BE FULLY HEAT TREATED RAILBOUND MAGANESE STEEL EXPLOSION HARDENED PER TRACKWORK SPECIFICATIONS.
- 4. ALL SPECIAL FROG PLATES SHALL BE 3/4" THICK WITH NO RAIL CANT.
- 5. ELASTOMER PADS SHALL BE 3/4" THICK AND EXTEND BEYOND THE FROG PLATES 1" ON ALL SIDES.
- 6. THE BONDED FROG AND BONDED CENTER FROG INSERTS SHALL BE MILLED CARBON STEEL CASTINGS AS SPECIFIED IN THE CONTRACT SPECIFICATIONS, AND AS SHOWN ON THIS DRAWING.


	10/22/2012	<u> </u>	222	REFERENCE DRAWINGS		200 W	REVISIONS	WASHINGTON METROPOLITAI	N AREA TRANSIT A	UTHORITY	TRACK	WORK DESIGN DRA	WING
DESIGNED .	RUREY	ES 4/08	NUMBER	DESCRIPTION		BY	DESCRIPTION	WASHINGTON METROLOGITAL	1 ANEA INAMON A	OHIORITI		RDED DOUBLE CROSSOVI	
DRAWN .	A. DAM	- GOE			1/01	CENT AUG	XED INFORMATION TO PLAN VIEW.	OFFICE OF ENGINEER	NG SUPPORT SERVICES			RS, DIAMOND & END FRO	
CHECKED .	R.ROCKEFEL	UER 7/07)	-12Packett	10 AMJ 7			DIRECT FIXATION TRACK	j
APPROVED.	LPADGETT				†			SUBMITTED 10/2007	APPROVED	10/2007 DATE	SCALE 1/4"=1'-0" 1 0 1 2 4FT	DRAWING NO. DD—TW—075	
			4				hard the same of t			2,000,000		DD-19-073	

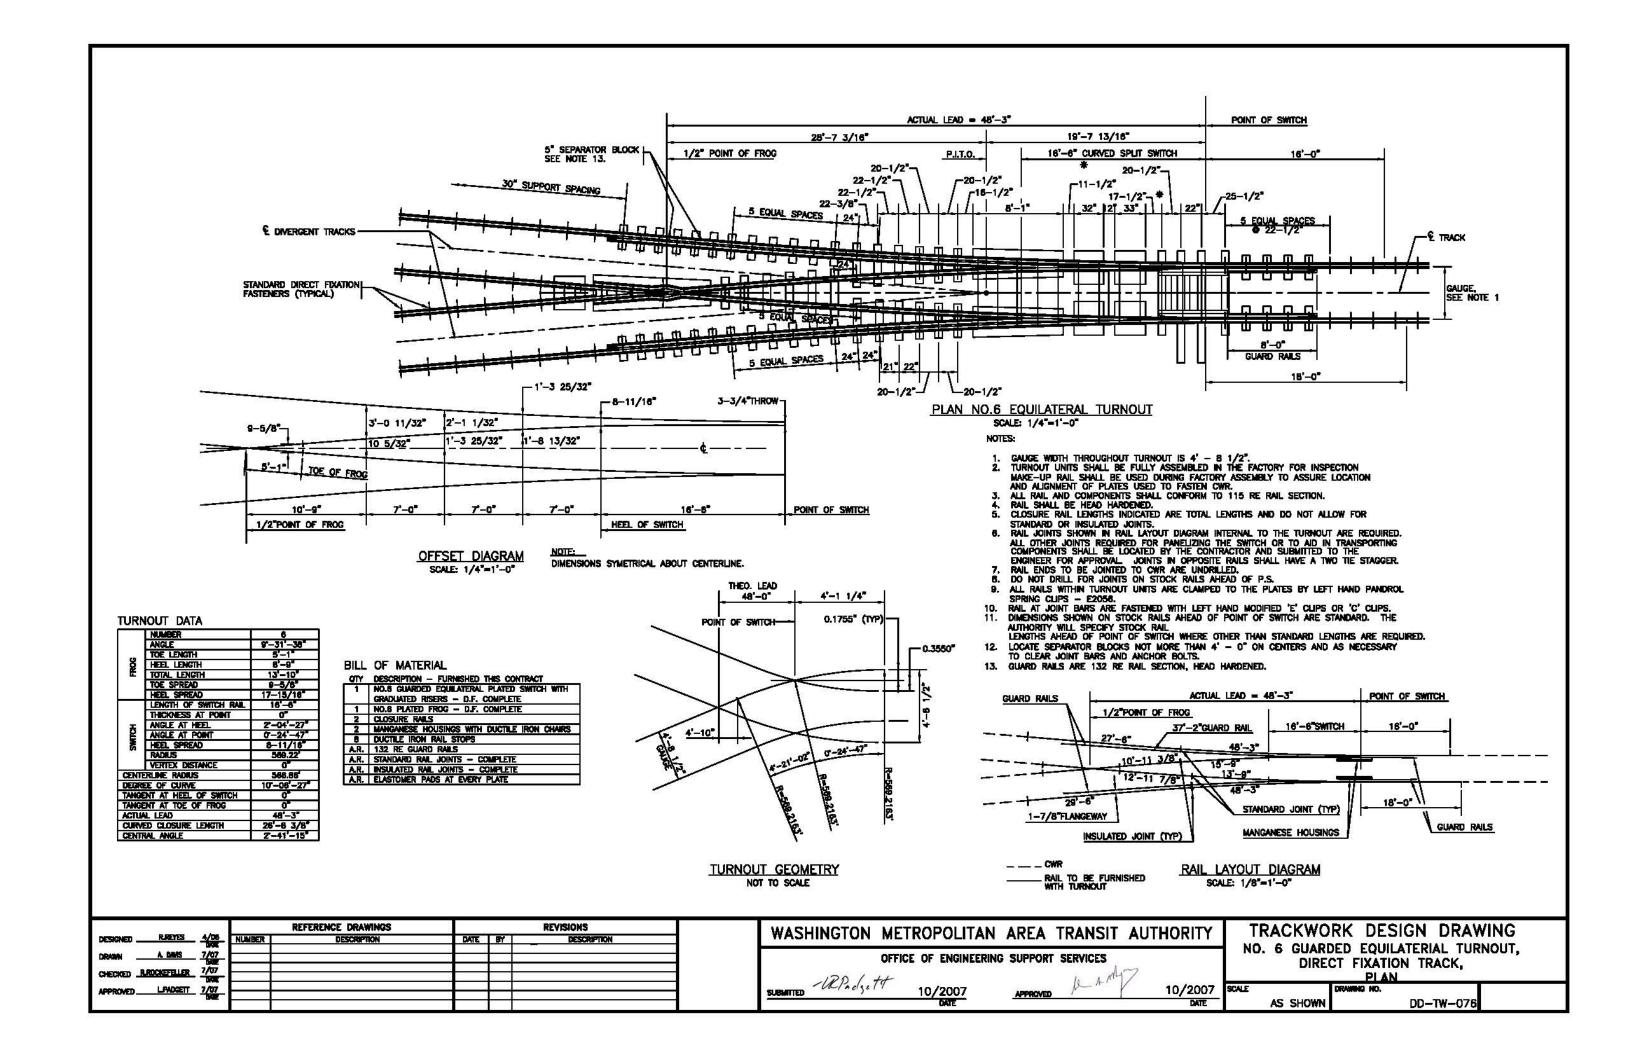


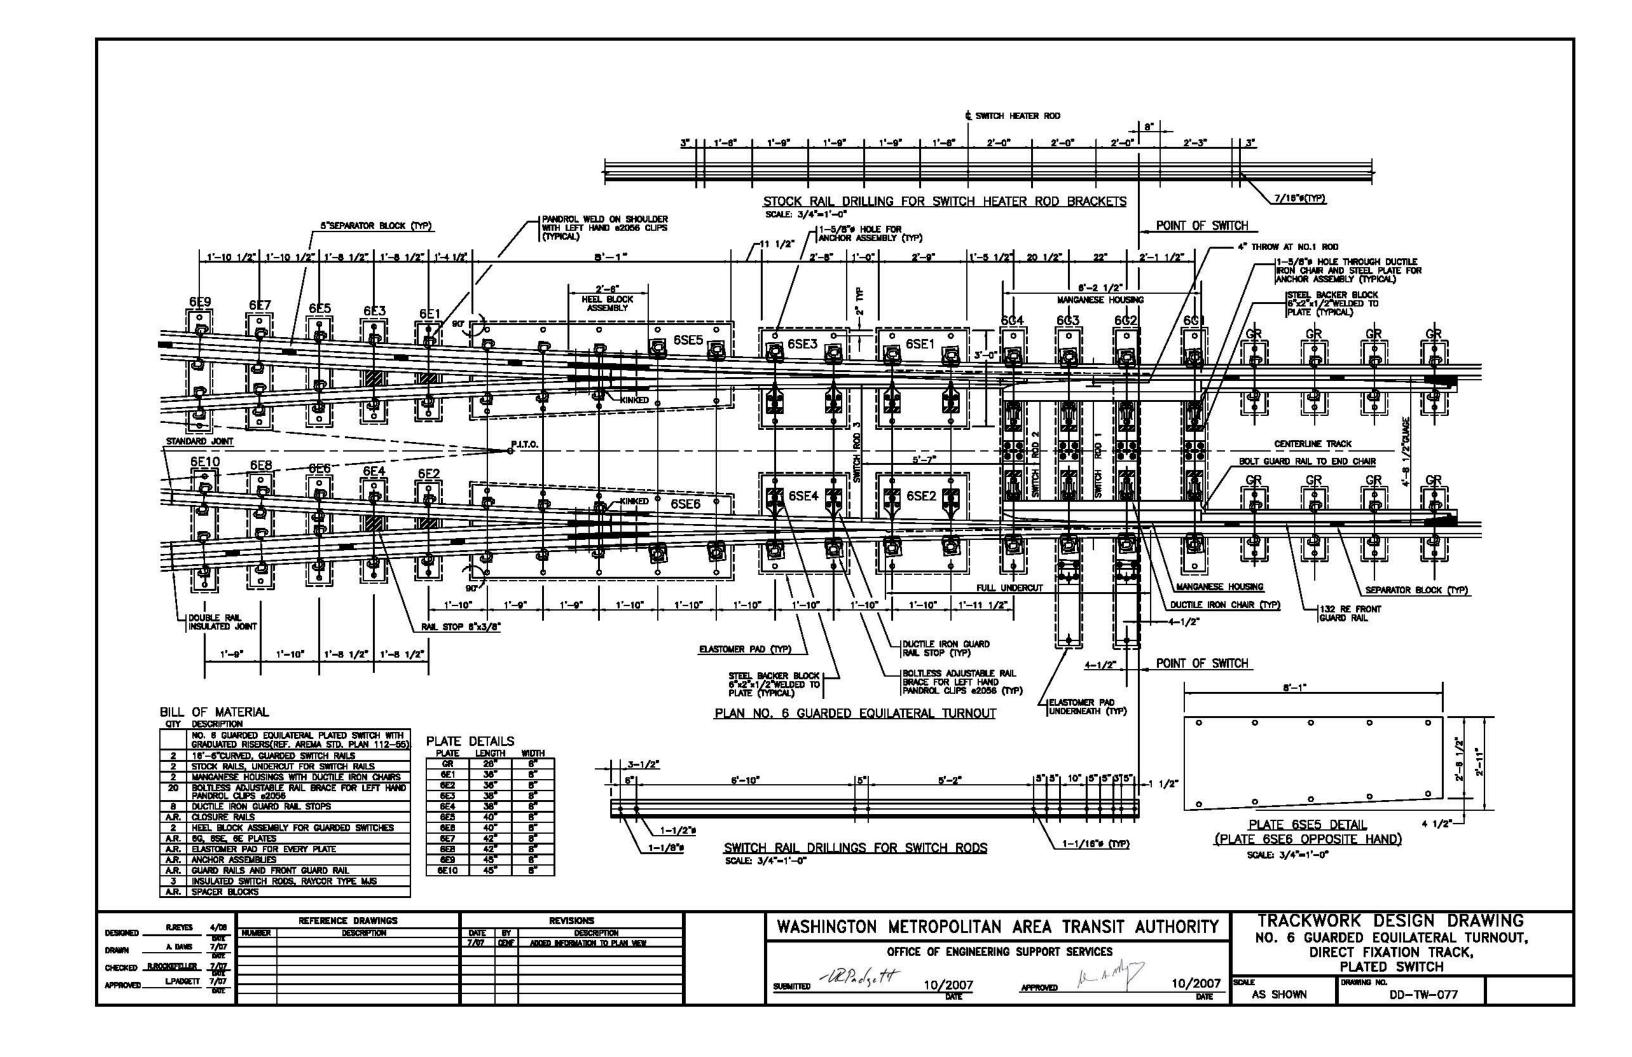


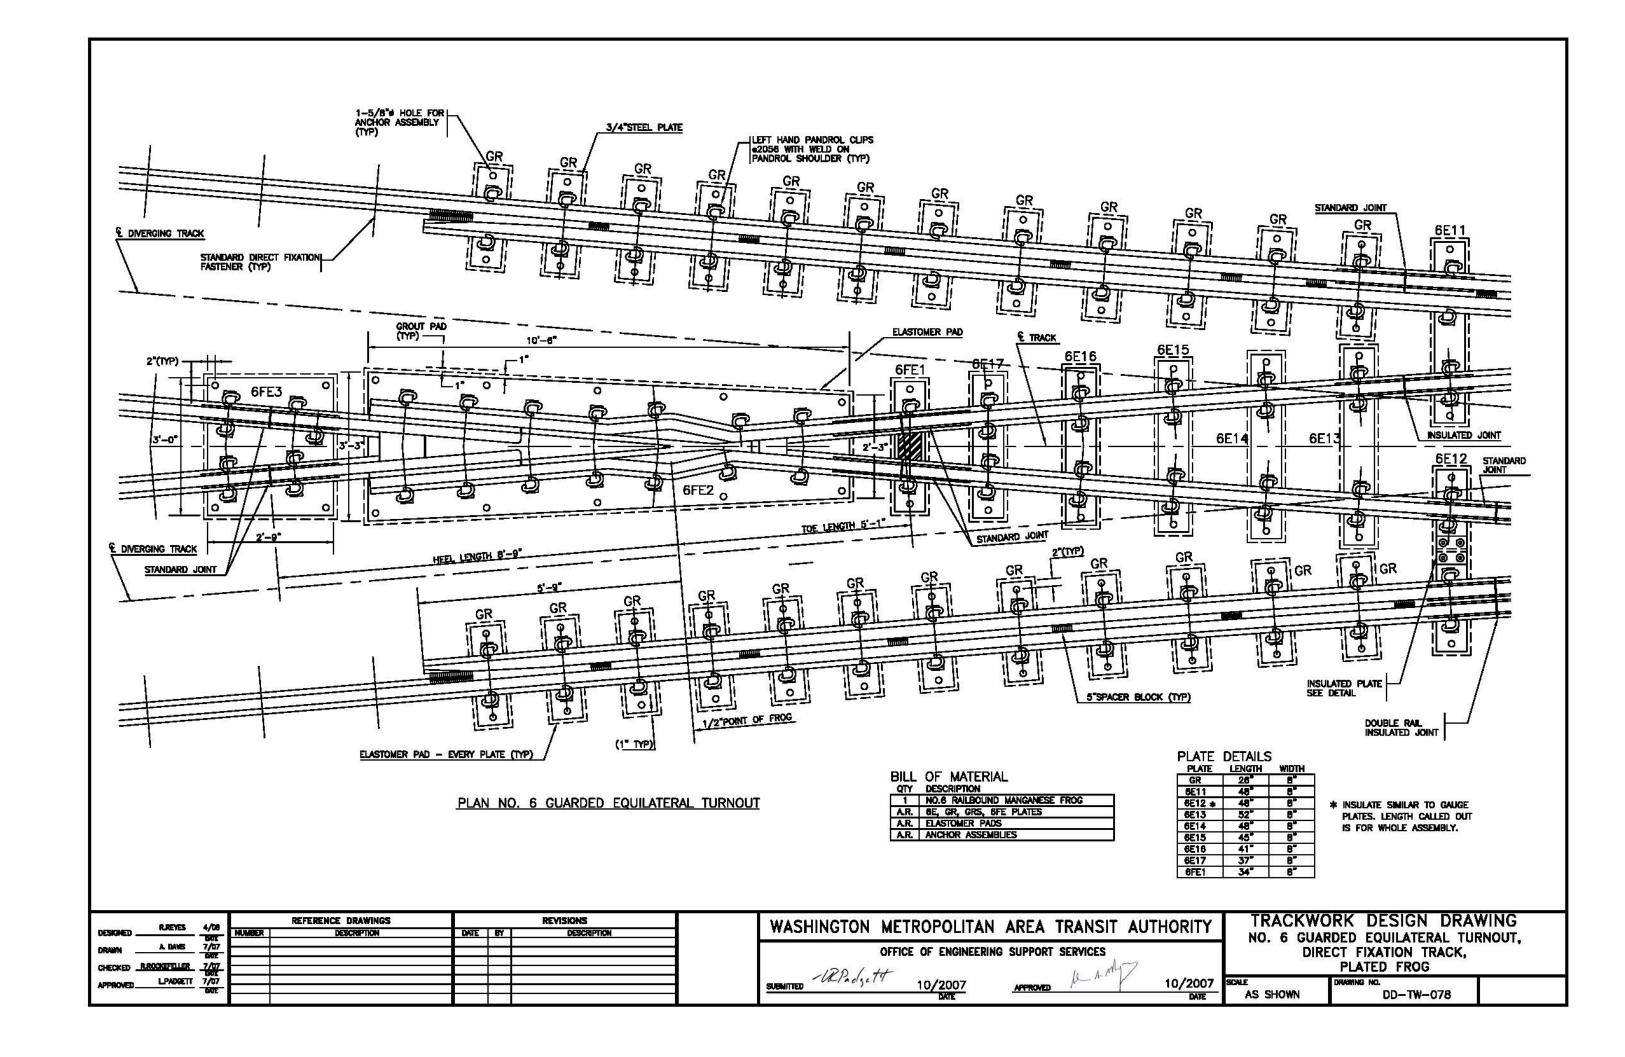


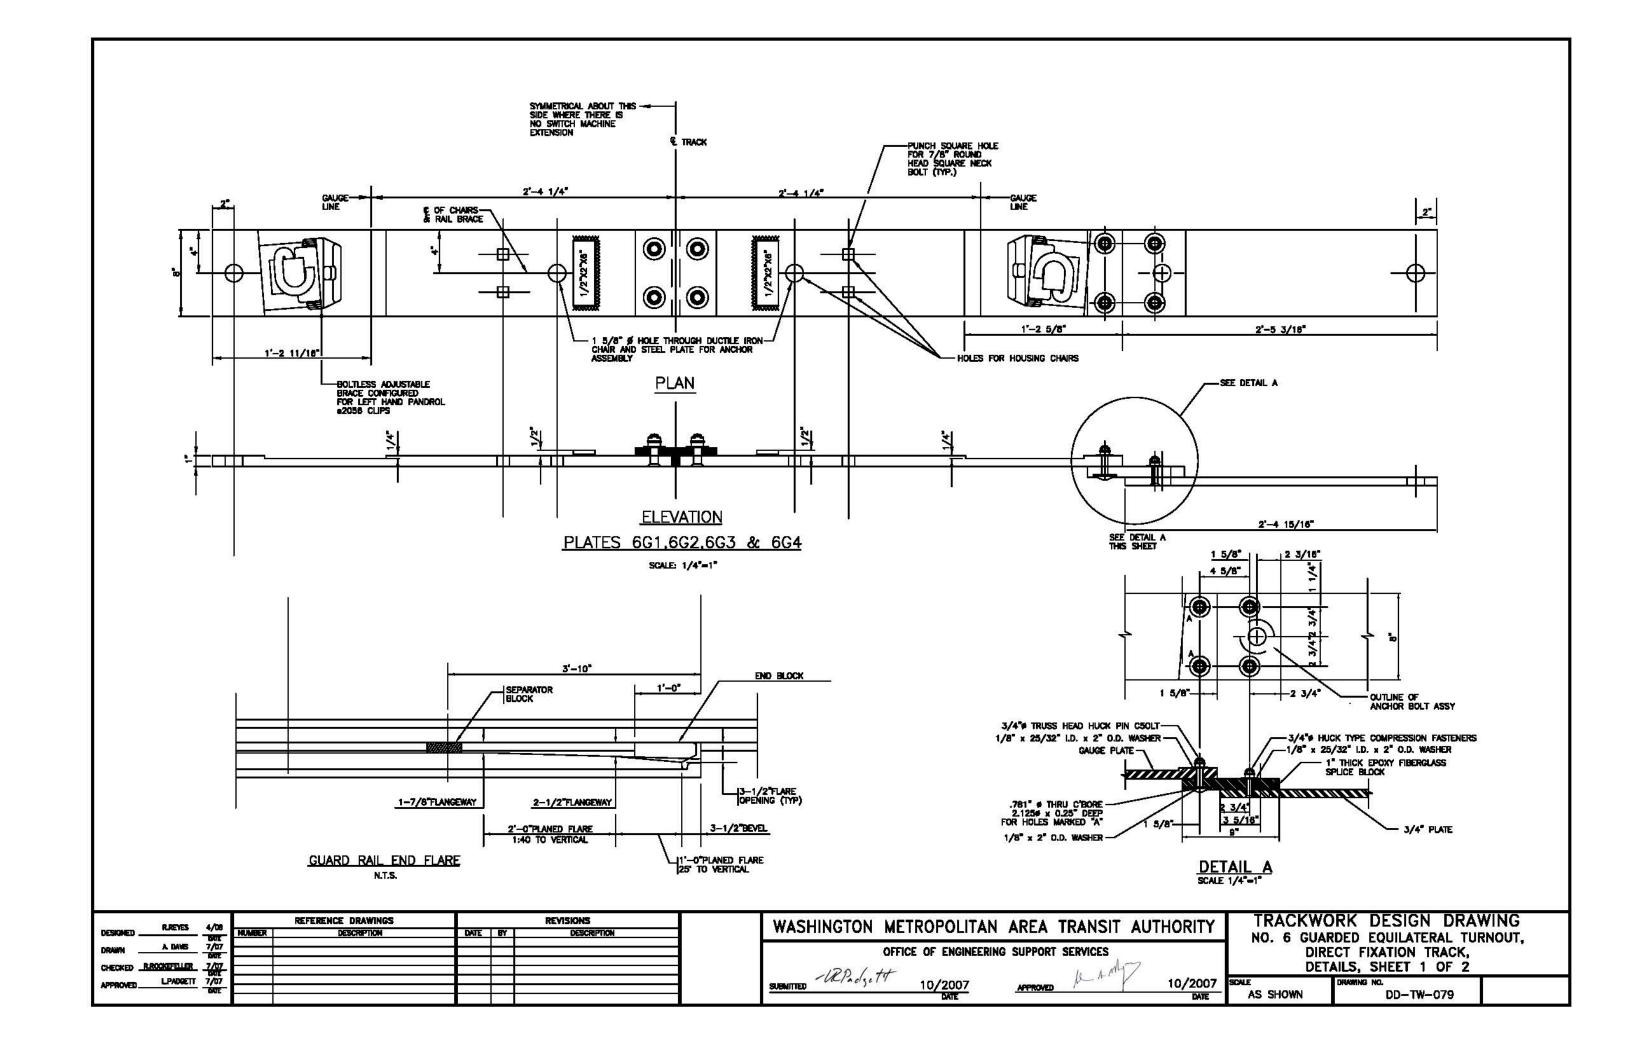

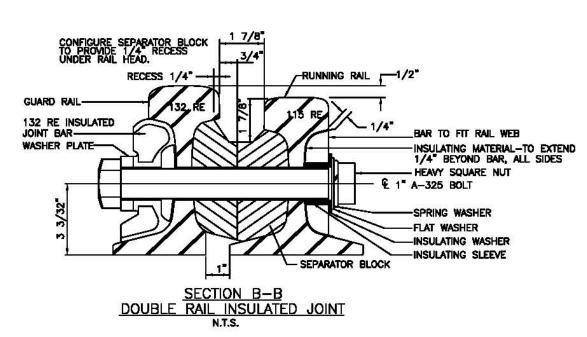

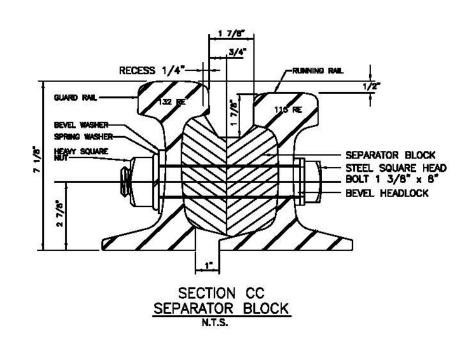

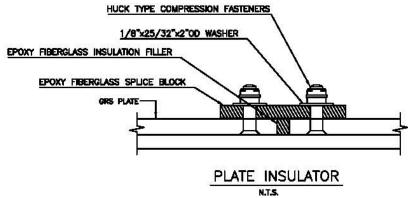

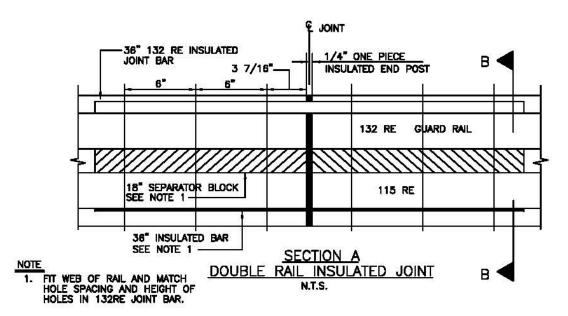


	RUREYES	4/08	R	EFERENCE DRAWINGS			REVISIONS
DESIGNED	KOŒ TES		NUMBER	DESCRIPTION	DATE	BY	DESCRIPTION
DRAWN	A DAVIS	7/07			07/07	CBF	CHANCE SEPARATOR BLOCK DETAIL TITLE
	ROCKEFELLER	7/07					E .
APPROVED_	LPADGETT	7/07					
	07	DOTE					

WASHINGTON	METROPOLITAN	AREA	TRANSIT A	UTHORITY
	OFFICE OF ENGINEERIN	G SUPPORT	SERVICES	
SUBMITTED -URPAdje	10/2007	APPROVED	be A My	10/2007
	NAME OF THE PARTY	450		PATE

10/2007 DATE APPROVED

TRACKWORK DESIGN DRAWING NO. 6 GUARDED EQUILATERAL TURNOUT, DIRECT FIXATION TRACK, DETAILS, SHEET 2 OF 2

AS SHOWN	080-WT-DD

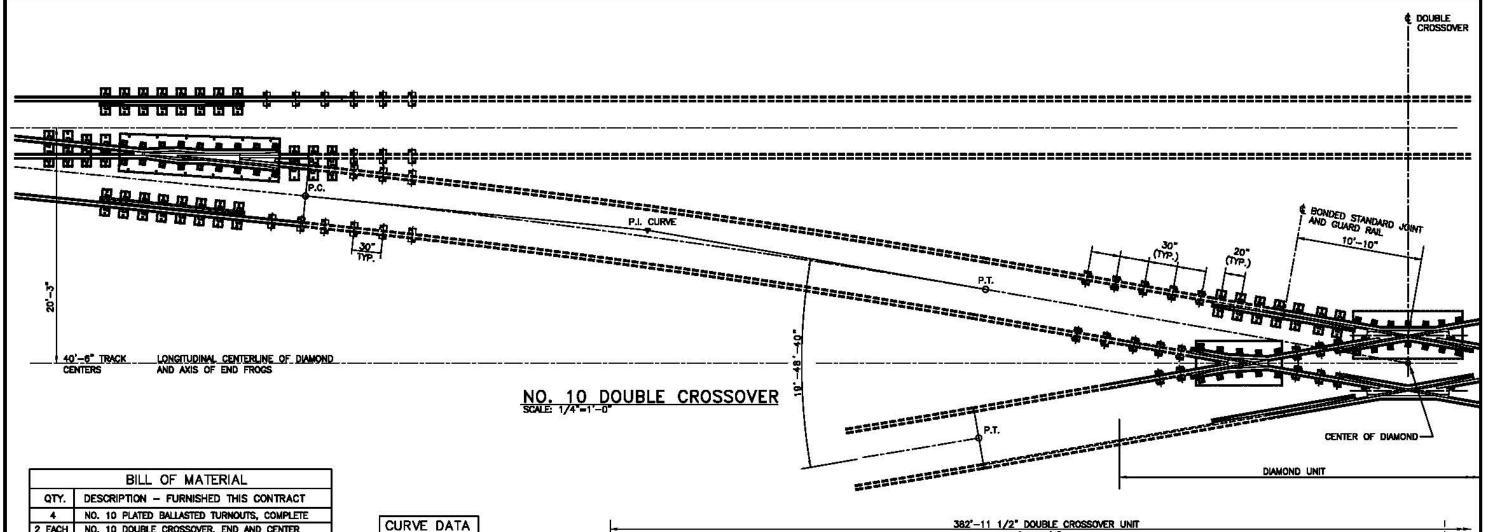


	DILL OF MATERIAL
QTY.	DESCRIPTION - FURNISHED THIS CONTRACT
4	NO. 10 PLATED BALLASTED TURNOUTS, COMPLETE
2 EACH	NO. 10 DOUBLE CROSSOVER, END AND CENTER FROG-G FOR 40'-8" TRACK CENTER DIAMOND
AR	BONDED STANDARD RAIL JOINTS, COMPLETE
A.R.	BONDED INSULATED RAIL JOINTS, COMPLETE
AR	ELASTOMER PADS AT EVERY PLATE FOR 7/8" SCREW SPIKES

	BILL OF MATERIAL
QTY.	DESCRIPTION - FURNISHED BY OTHERS
A.R.	GROUT PADS
AR.	INSERT AND ANCHOR ASSEMBLY, ANCHORING MATERIAL
A.R.	BONDED RAIL JOINTS TO CONNECT TURNOUTS AND DIAMOND TO CWR


CUR	VE DATA
Δ	4"-10"-51"
R	812.84
T	29.67
Lc	59.3142
E	6 7/8"
SF	0


- 1. SEE DWG No. TW2007-52 FOR No.10 TURNOUT DATA.
- 2. CROSSOVER IS SYMMETRICALLY ROTATED ABOUT CENTER OF DIAMOND.

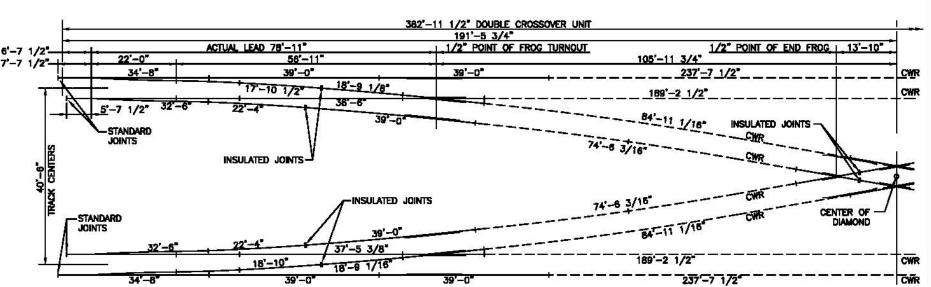



NO. 10 DOUBLE CROSSOVER, RAIL LAYOUT DIAGRAM SCALE: 3/32"=1'0"


Apper March March		REFERENCE DRAWINGS REVISIONS				TWANHING ION METRIPOLIAN AREA TRANSII ALLIHORUT I								TRACKWORK DESIGN DRAWING		
DESIGNED	- Total	NUMBER	DESCRIPTION	DATE				MASI	IIINGTON ME	INOI OLITAI	ANLA	INAMOIT AU	HORH		ED DOUBLE CROSSOVER	
DRAWN	-DOE-					ADDED INFORMATION TO PLAN WE'K REVISED DELTA ANGLE			OFFICE	OF CHIEF ENGINEE	ER – FACILI	TIES			, 40'-6" TRACK CENT	
CHECKED REPORTELLER	10/07				上				- URPadatt			10 AMY		DI	RECT FIXATION TRACK	30.04 (0.05
APPROVED LPAGGETT	10/07 DOE							SUBMITTED	- Valadge 14	10/2007	APPROVED	<i>y</i> — <i>y</i>	10/2007	SCALE NOT TO SCALE	DRAWNG NO. DD-TW-081	
						Ú				LAIL			LIAIE		23	

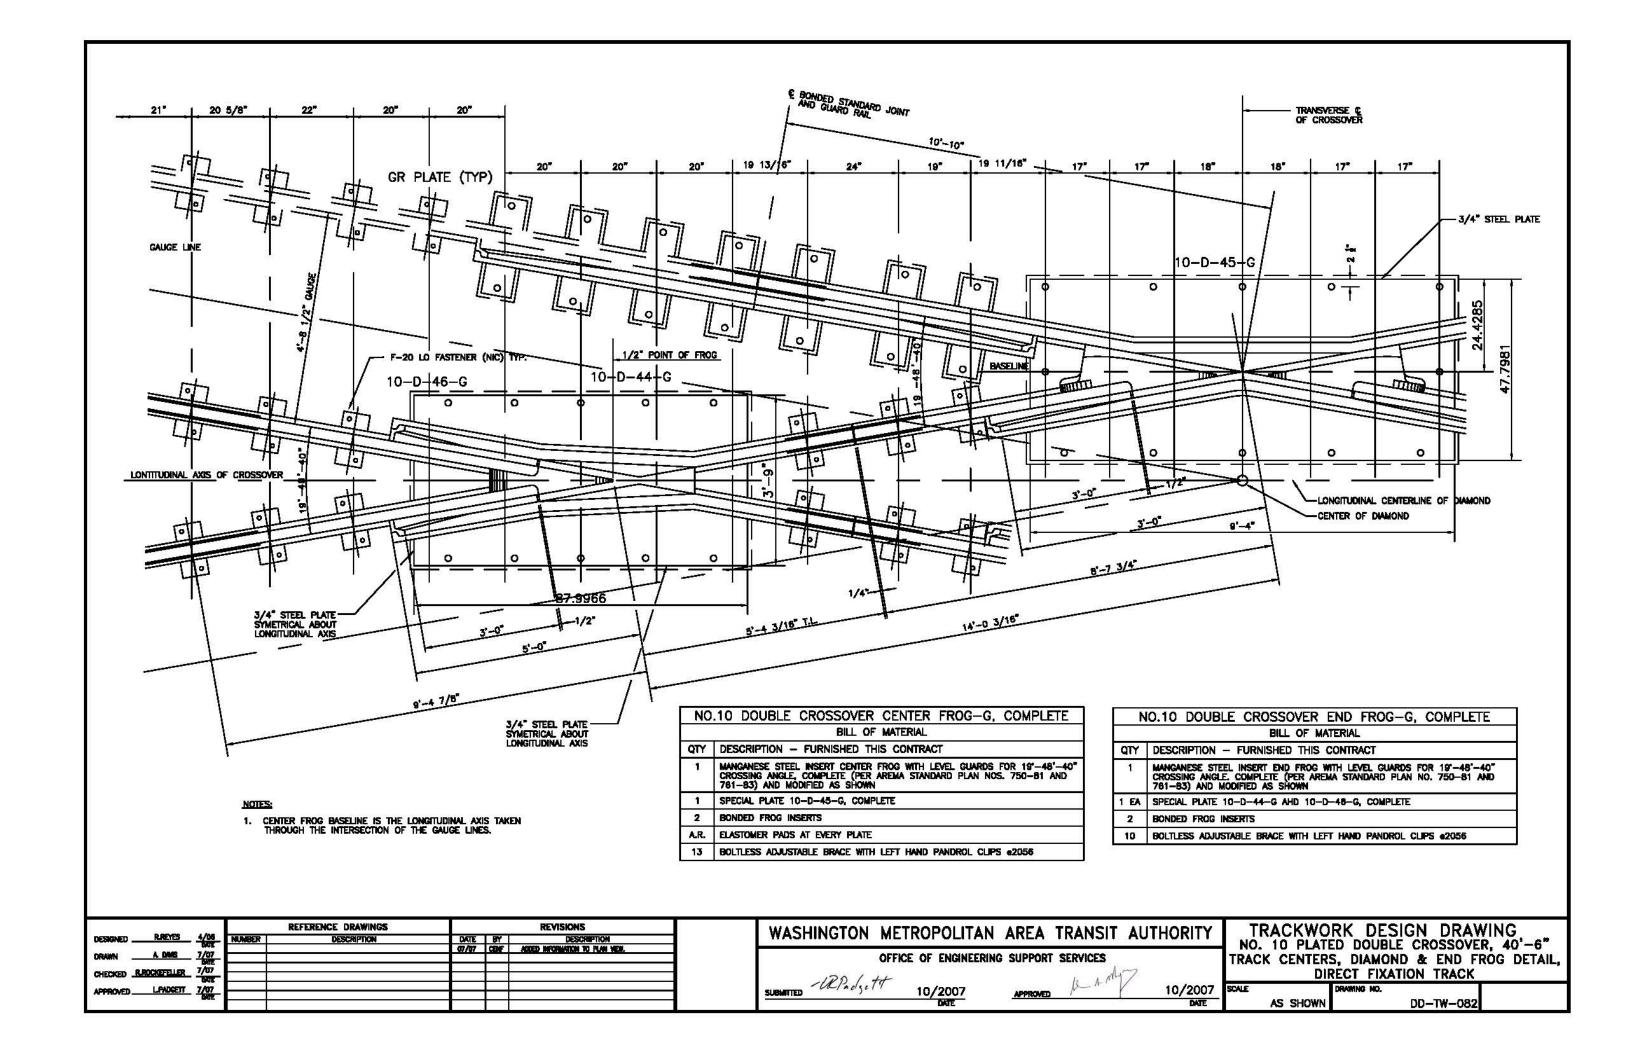


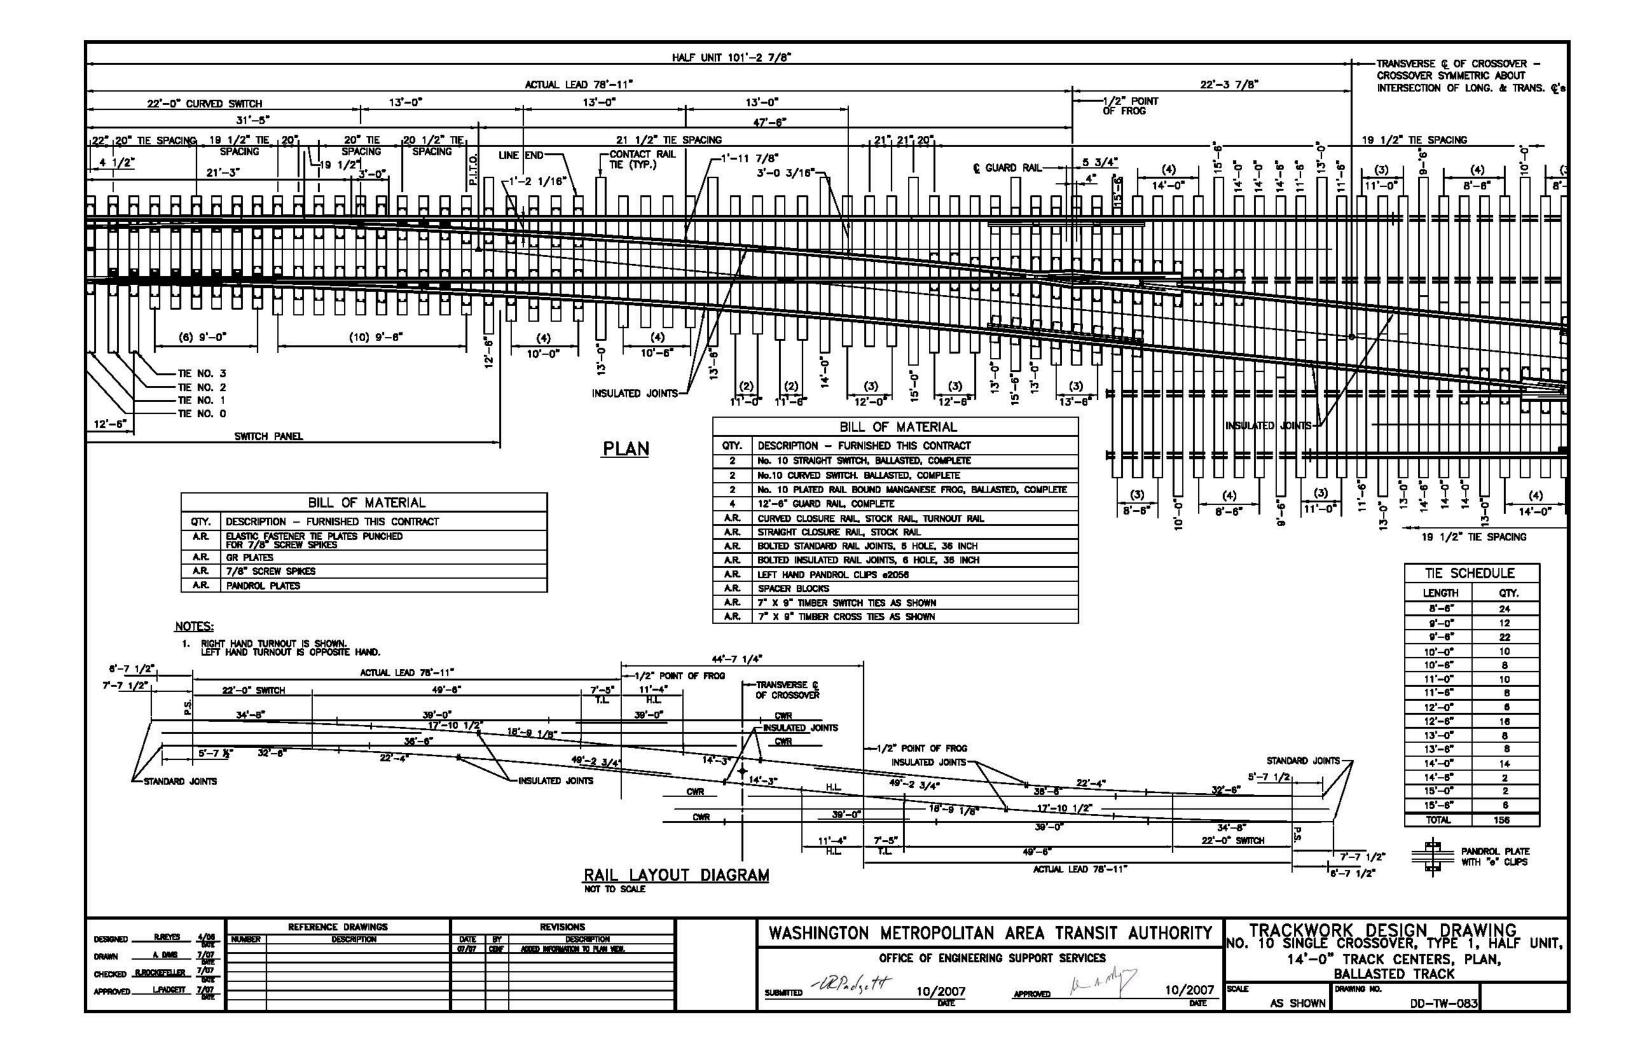


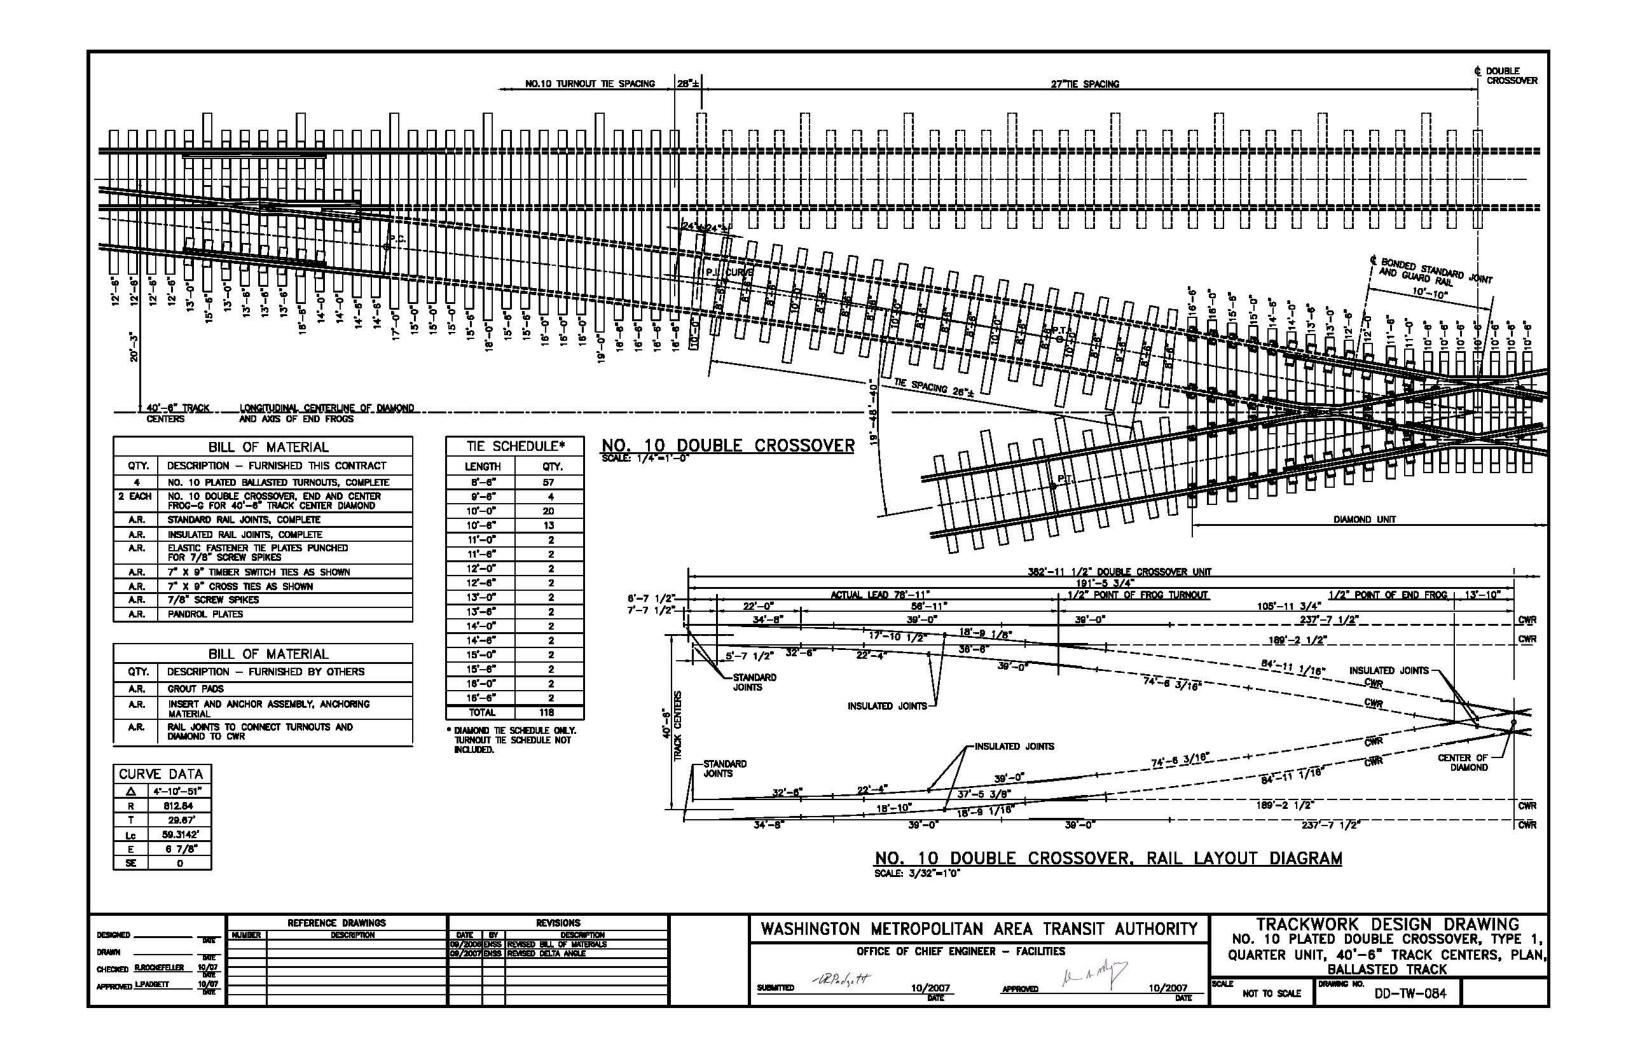

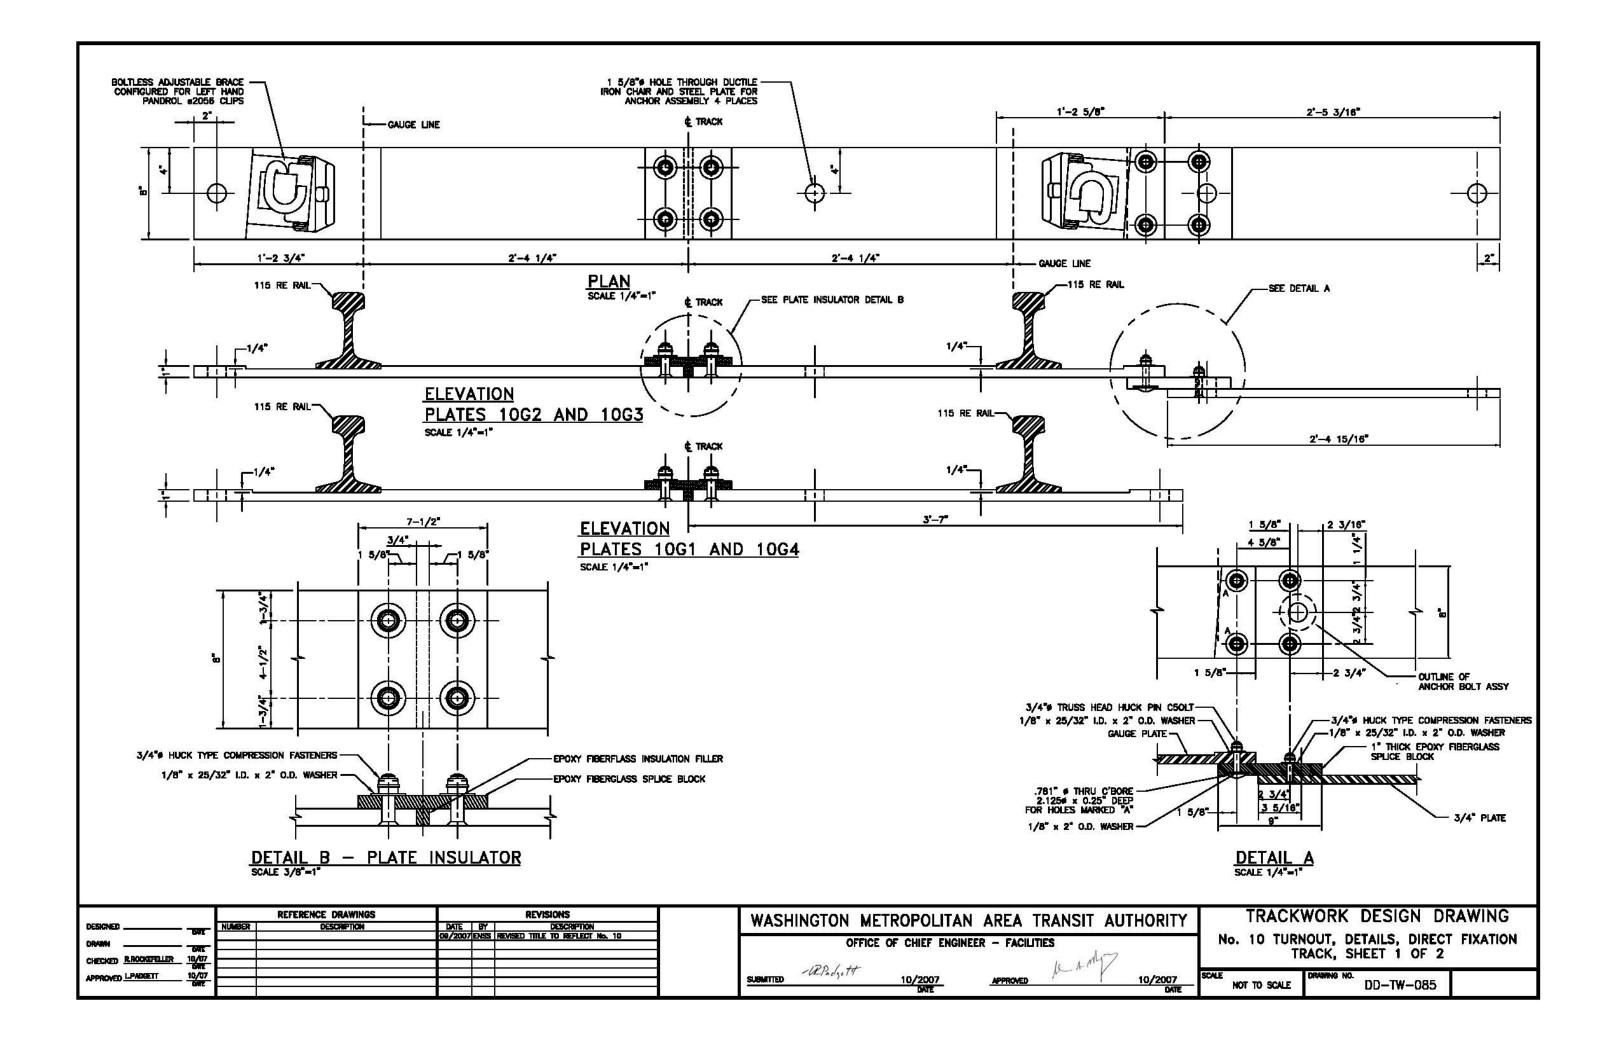

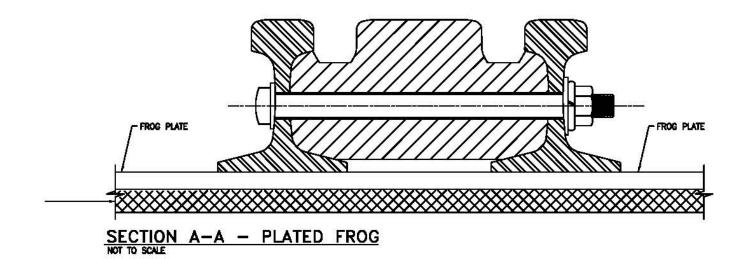

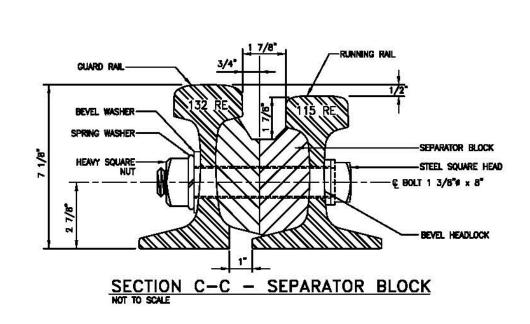

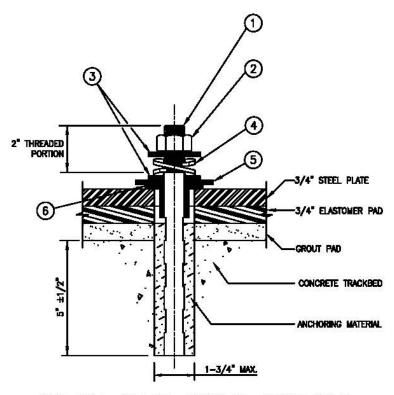

SPECIAL	PLATE	ANCHOR	ASSEMBLY
NOT TO SCALE			


215	E	BILL OF MATERIAL - ANCHOR ASSEMBLY
ITEM	QTY.	DESCRIPTION — FURNISHED BY OTHERS
1	1	STEEL STUD 7/8"x10" ASTM-A449
2	1	STEEL HEX NUT FOR 7/8" BOLT, WASHER FACED, ASTM-A-325
3	2	STEEL WASHER, 15/16" I.D., 2-1/4" O.D., 3/16" THICK, ASTM-A-325
4	1	DOUBLE COIL SPRING WASHER
5	1	INSULATING FIBER WASHER, 1—9/32" I.D., 3—3/8" O.D.
6	1	ONE PIECE — INSULATING FIBER WASHER (29/32" I .D., 2-1/2" O.D.) AND INSULATING FIBER SLEEVE (29/32" I.D., 1-9/32" O.D.)


		REFERENCE DRAWINGS			REVISIONS	
OESIGNED	NUMBER	DESCRIPTION	DATE	EVEC	DESCRIPTION REVISED TITLE TO REFLECT No.	
ORANA GOT			GB/ 2007	ENSS	NEVISED THEE TO REPLECT NO.	10
CHECKEN R.ROCKEFELLER 10/07						
APPROVED LPADGETT 10/07						
OUR						


WASH	INGTON	METROPOLITAN	AREA	TRANSIT	AUTHORITY
	0	FFICE OF CHIEF ENGINE	ER – FACIL	JIJES ,	losa
SUBMITTED	-URPadgets	10/2007	APPROVED	he 1 ml	10/2007
	55.	DATE	ATTROVED	70000	DATE

	TR.	ACKWOR	K DES	SIC	N	DR	AWING
NO.	10	TURNOUT,		- Y-200			FIXATION
		TRACK,	2HFF1	2	OF	Z	

-	scale Not to scale	DEMANUS NO.	-TW-086	
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TYPE OF TIE AT THE RECOMMENDED SPACING	WIDTH OF BALLAST SHOULDER (X)
7"x 9" x 8'-6" WOOD	10"
MONOLITHIC CONCRETE	12"
2 - BLOCK CONCRETE	6"

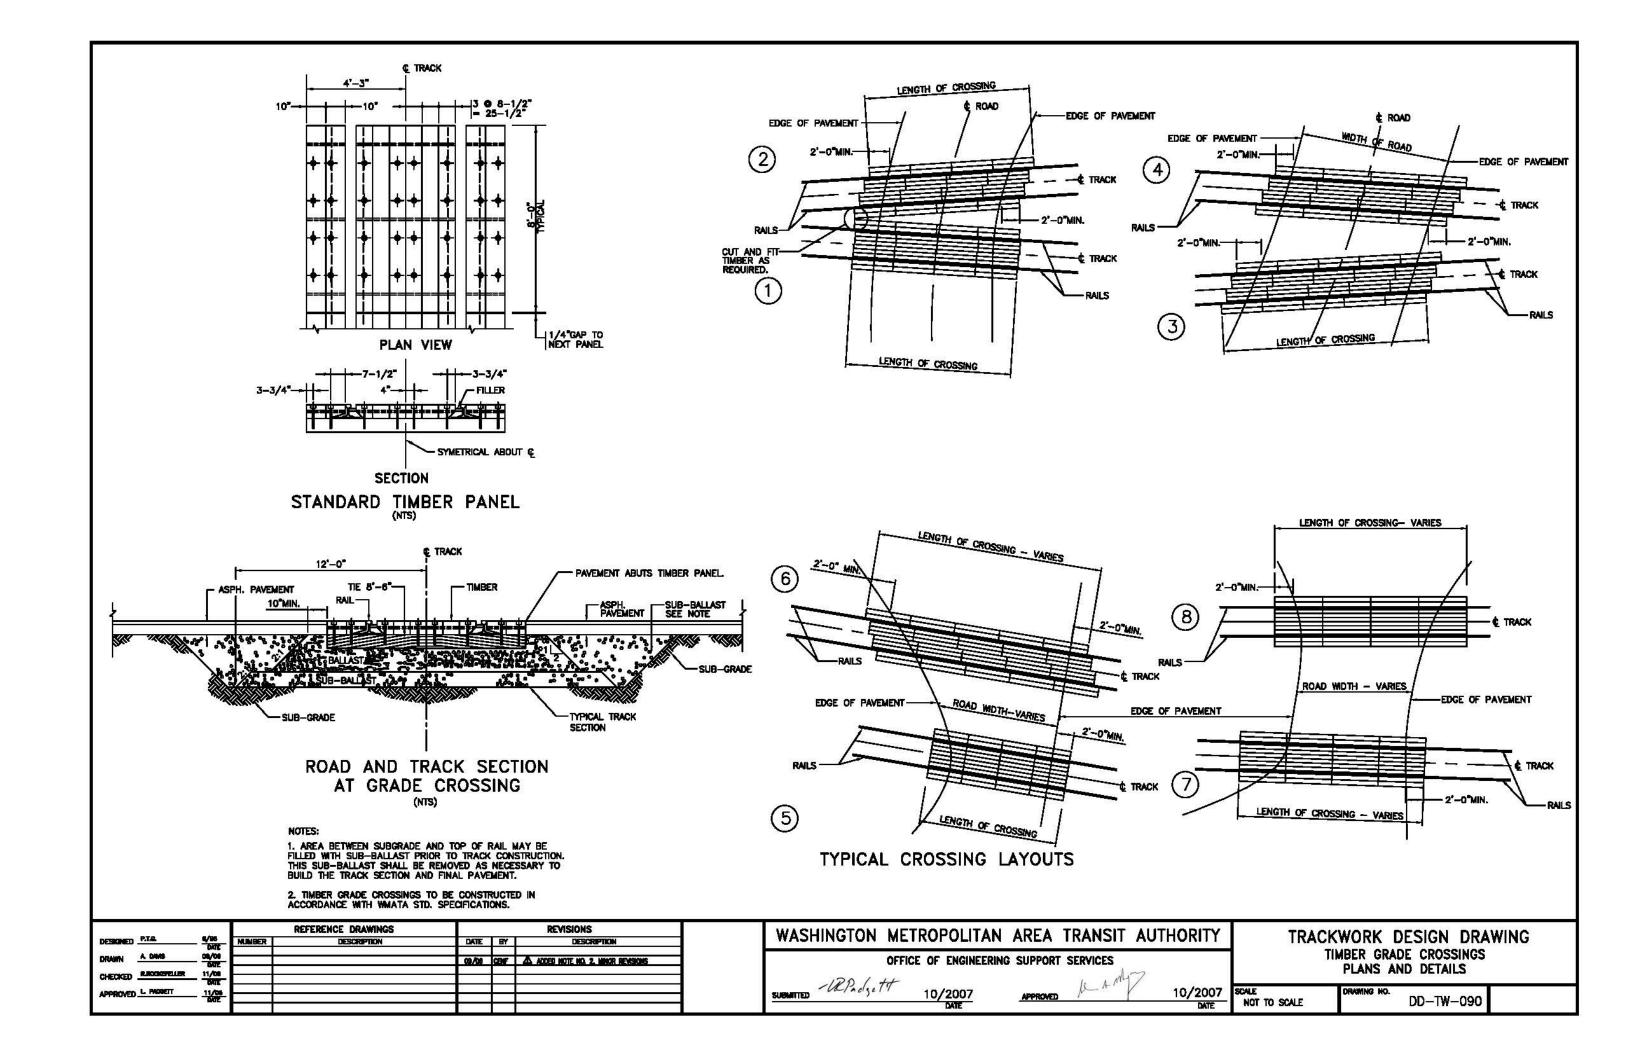- STANDARD ROADBED & BALLAST SECTION FOR SUPER ELEVATED TRACK
 - AUTHORITY'S CONSIDERATION. 2. WHERE THERE IS NO SERVICE ROAD ON EITHER SIDE, THE SUB BALLAST BERM SHALL BE 2'-8" ON BOTH SIDES OF TRACK. 3. SLOPE TO BE DEPENDENT ON THE REQUIREMENTS 4. THE TRANSITION FROM THE ROADBED AND BALLAST SECTION IS SHOWN FOR TANGENT TRACK. THE ROADBED AND BALLAST SECTION SHOWN FOR SUPER ELEVATED TRACK MAY BE MADE

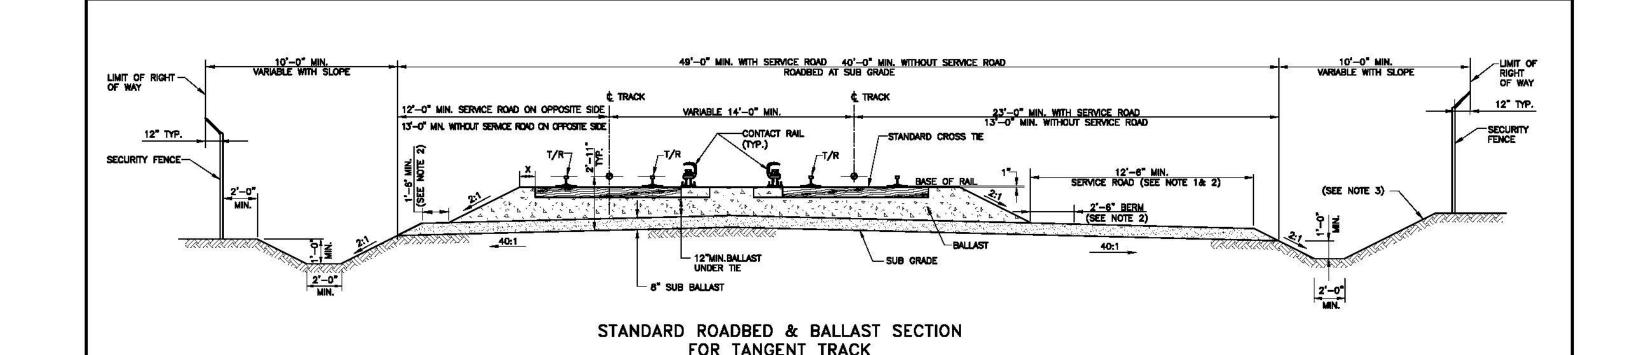
	l R	REFERENCE DRAWINGS		REVISIONS	
DESIGNED K. Wojelcki 6-200 0/00	MAMBER	DESCRIPTION	DATE	BY	DESCRIPTION
DRAWN K. Wojcield 6-200					
CHECKED LR Podgett 6-200					
APPROVED L.R. Padgett 8-200					
MUE					

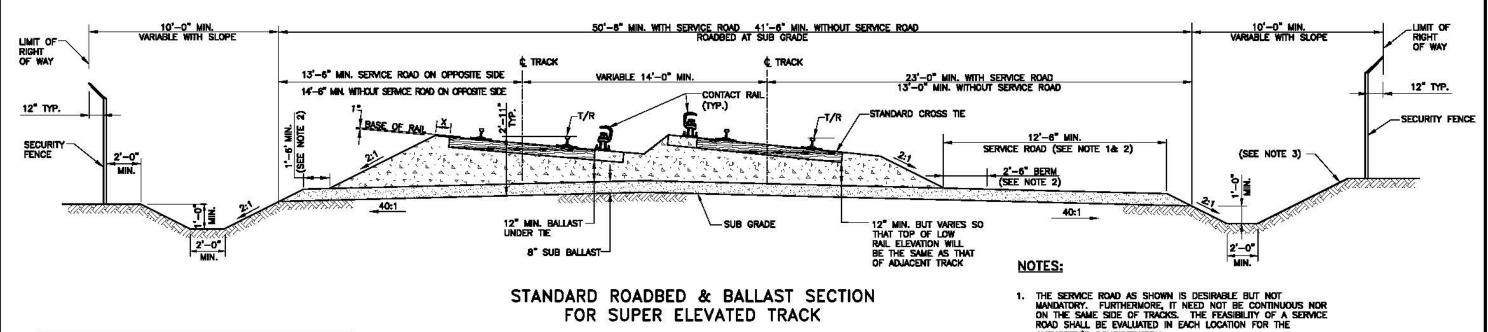
WASHINGTON	N METROPO	LITAN AREA	TRANSIT	AUTHORITY	
	OFFICE OF EN	GINEERING SUPPORT	SERVICES	~~'	1
SUBMITTED -URPAds	10/20	07 APPROVED	le 1 m	10/2007	SC
	DATE	3		DATE	

TRACKWORK DESIGN DRAWING STANDARD ROADBED & BALLAST SECTION METRO ON EXCLUSIVE RIGHT-OF-WAY

DD-TW-110

THROUGH THE LENGTH OF THE SPIRAL.

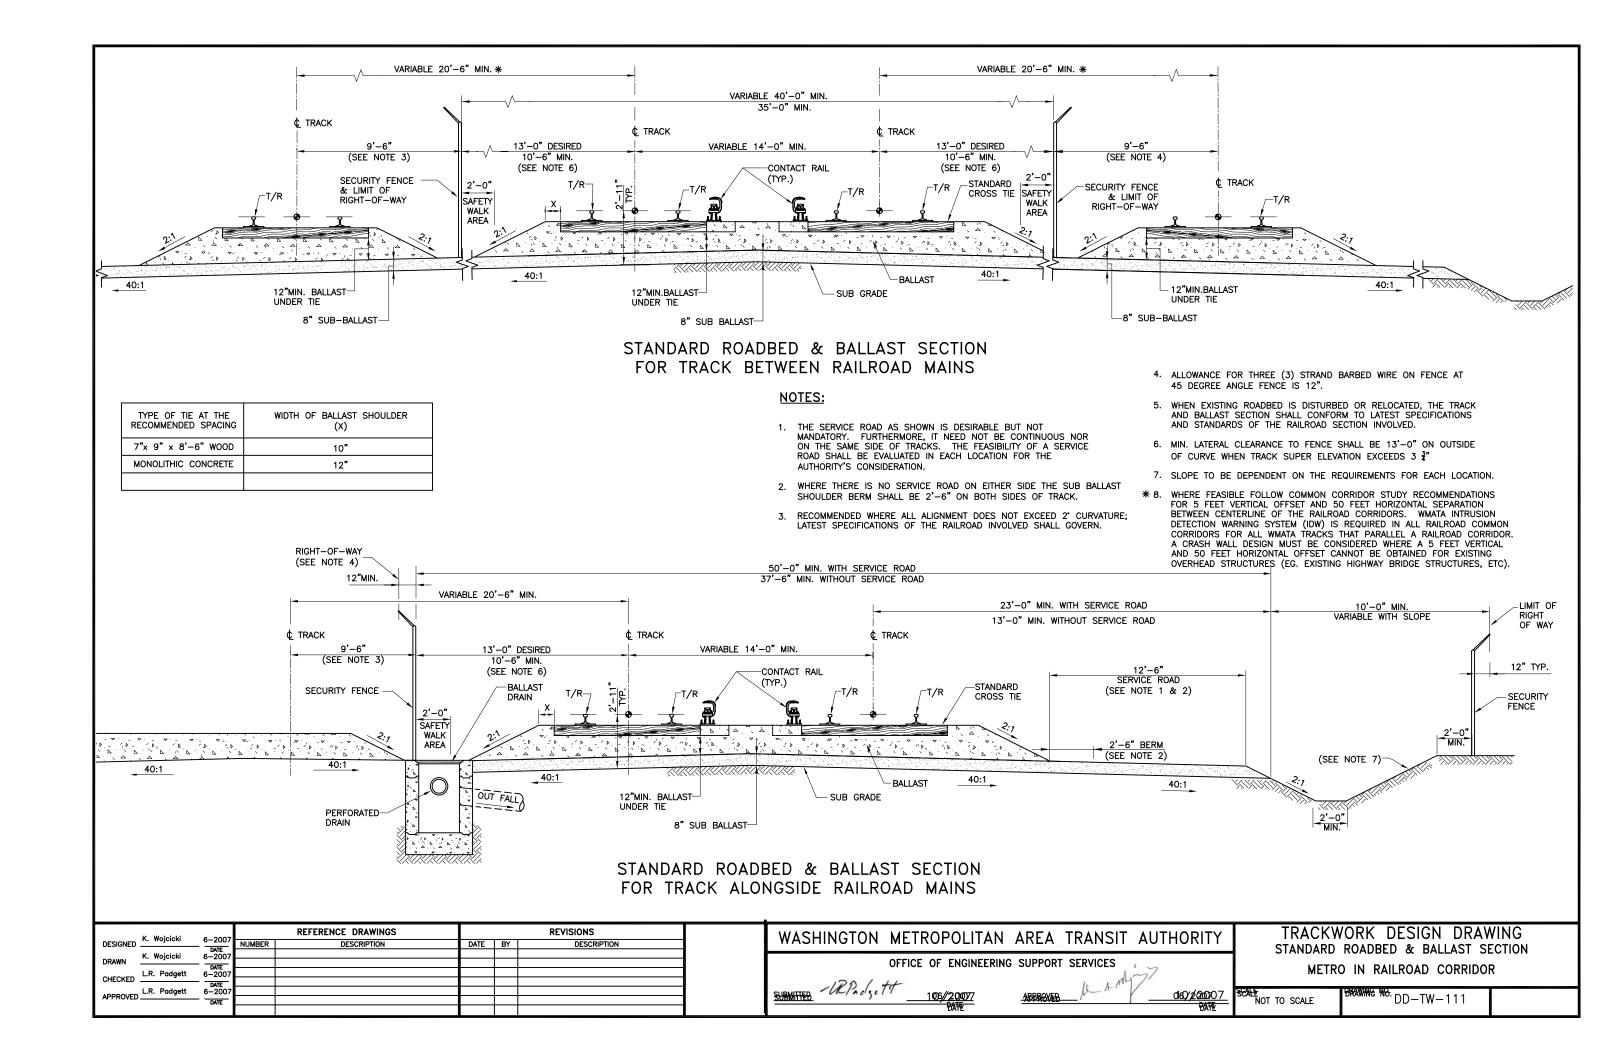

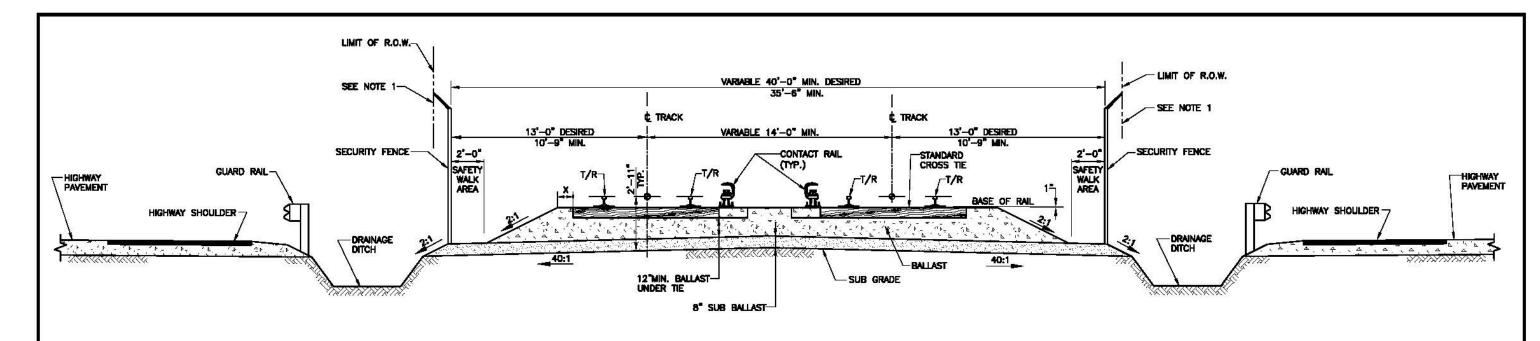


STANDARD ROADBED & BALLAST SECTION FOR TANGENT TRACK IN HIGHWAY MEDIAN

TYPE OF TIE AT THE RECOMMENDED SPACING	WIDTH OF BALLAST SHOULDER (X)
7"x 9" x 8'-6" WOOD	10"
MONOLITHIC CONCRETE	12"


NOTES:

1. ALLOWANCE FOR FENCE IS 12" INSIDE WMATA PROPERTY.

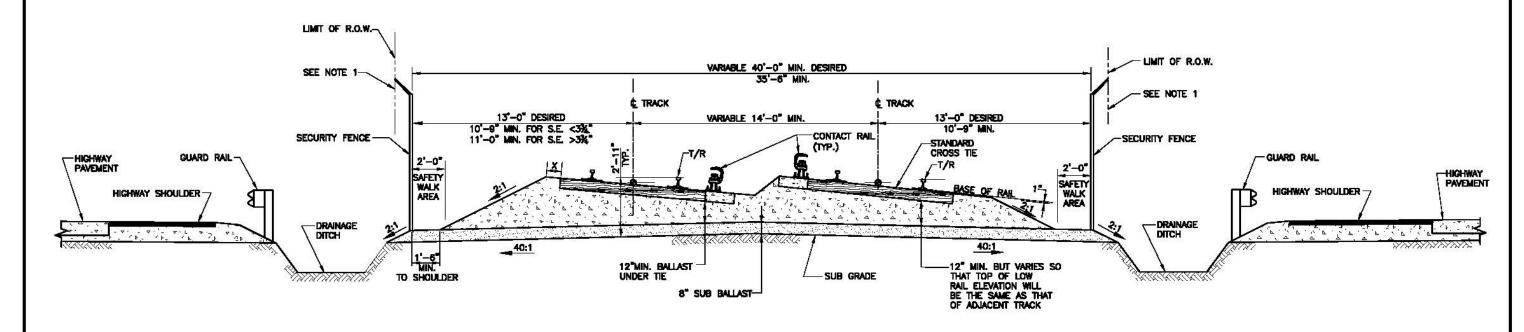

STANDARD ROADBED & BALLAST SECTION FOR SUPER ELEVATED TRACK IN HIGHWAY MEDIAN

1	REFERENCE DRAWINGS	REVISIONS	WASHINGTON METROPOLITAN AREA TRANSIT AUTHORITY TRACKWORK DESIGN DRAWING
DESIGNED K. Wojelchi 6-2007	NUMBER DESCRIPTION	DATE BY DESCRIPTION	STANDARD ROADBED & BALLAST SECTION
DRAWN K. Wojcicki 6-2007 GATE CHECKED L.R. Padgett 6-2007			OFFICE OF ENGINEERING SUPPORT SERVICES METRO IN HIGHWAY MEDIAN
APPROVED L.R. Padgett 8-2007			SUBMITTED TO SCALE DRAWING NO. DD-TW-112

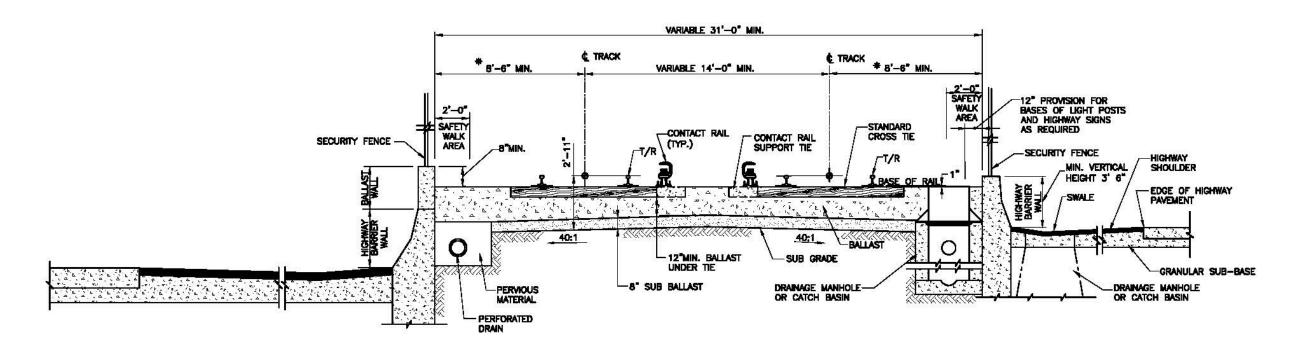


MINIMUM WIDTH ROADBED & BALLAST SECTION IN RESTRICTED HIGHWAY MEDIANS

* ALLOWANCES FOR CURVATURE SHALL BE ADDED WHERE APPLICABLE.


- 1. PROVIDE INLET MANHOLES IN ACCORDANCE WITH DO-M-23
- 2. BOTH 14'-0" MIN. TRACK CENTERS AND 8'-6" MIN. SIDE CLEARANCE SHALL BE INCREASE FOR CURVATURE AND SUPER ELEVATION AS PER DESIGN CRITERIA.

	REFERENCE DRAWINGS	REVISIONS	WASHINGTON METROPOLITAN AREA TRANSIT AUTHORITY	TRACKWORK DESIGN DRAWING
DESIGNED K. Wojolchi 6-2007	NUMBER DESCRIPTION	DATE BY DESCRIPTION	WASHINGTON METROLOGITAN AREA TRANSH ACHTORITI	STANDARD ROADBED & BALLAST SECTION
DRAWN K. Wojcicki 6-2007			OFFICE OF ENGINEERING SUPPORT SERVICES	Control Contro
CHECKED LR. Podgett 6-2007		 	120 / 44	METRO IN RESTRICTED HIGHWAY MEDIAN
APPROVED L.R. Padgett 8-2007			SUBMITTED -URPACISETY 10/2007 APPROVED 10/2007	SCALE DRAWING NO. DD—TW—113
au.			DATE	NOT TO SCALE DD-1W-113

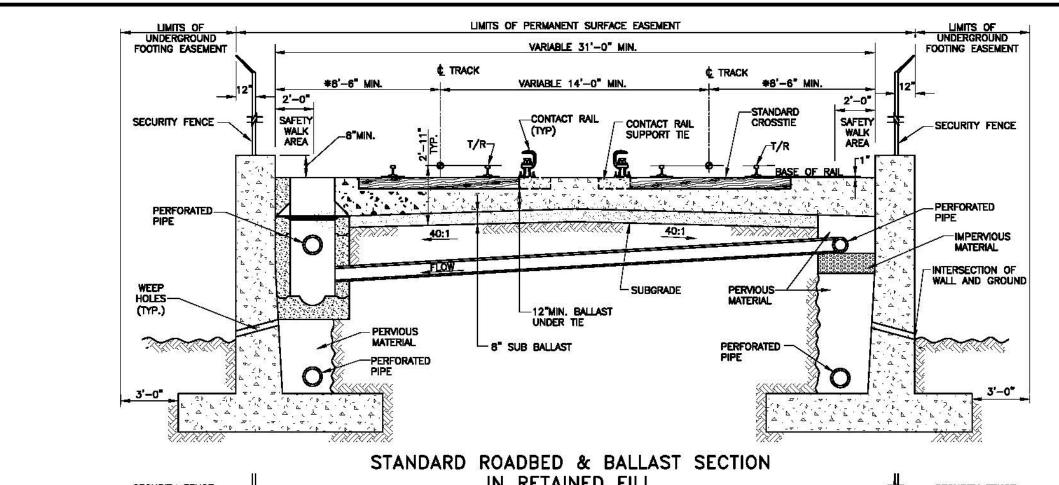

NOTES:


- 1. RETAINING WALL FORM AND DETAILS COVERED ELSEWHERE. LIMITS OF UNDERGROUND FOOTING EASEMENT.
- APPLICABLE DIMENSIONS SHOWN ON THIS DRAWING SHALL ALSO GOVERN FOR TRACK ADJACENT TO A SINGLE RETAINING WALL OR FOR A SINGLE METRO TRACK IN RETAINING CUT OR FILL LOCATION.
- 3. PROVIDE INLET MANHOLES IN ACCORDINANCE WITH DD-M-23.
- 4. REFER TO ST-U-34 FOR MOUNTING WMATA'S SECURITY FENCE ON THE RETAINING WALL.
- 5. BOTH 14'-O" MIN. TRACK CENTERS AND 8'-6" MIN. SIDE CLEARANCE SHALL BE INCREASE FOR CURVATURE AND SUPERELEVATION AS PER DESIGN CRITERIA.

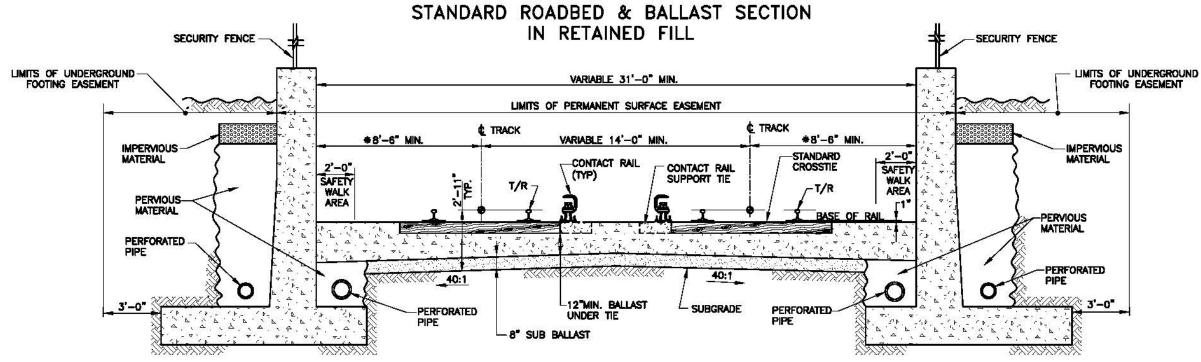

STANDARD ROADBED & BALLAST SECTION IN RETAINED CUT

* ALLOWANCE FOR CURVATURE AND SUPER ELEVATION SHALL BE ADDED WHERE APPLICABLE

	REFERENCE DRAWINGS	REVISIONS	WASHINGTON METROPOLITAN AREA TRANSIT AUTHORITY	TRACKWORK DESIGN DRAWING
DESIGNED K. Wojolchi 6-2007	NUMBER DESCRIPTION	DATE BY DESCRIPTION	WASHINGTON METROLOGITAN AREA INANSII AGIIIONIII	STANDARD ROADBED & BALLAST SECTION
DRAWN K. Wojckid 6-2007			OFFICE OF ENGINEERING SUPPORT SERVICES	
CHECKED LR. Podgett 6-2007			120/44	METRO IN RETAINING WALL SECTION
APPROVED L.R. Padgett 8-2007			SUBMITTED URP Sett 10/2007 APPROVED 10/2007	SCALE DRAWING NO. DD—TW—114
	1		DATE	NOT TO SCALE DD THE TITE

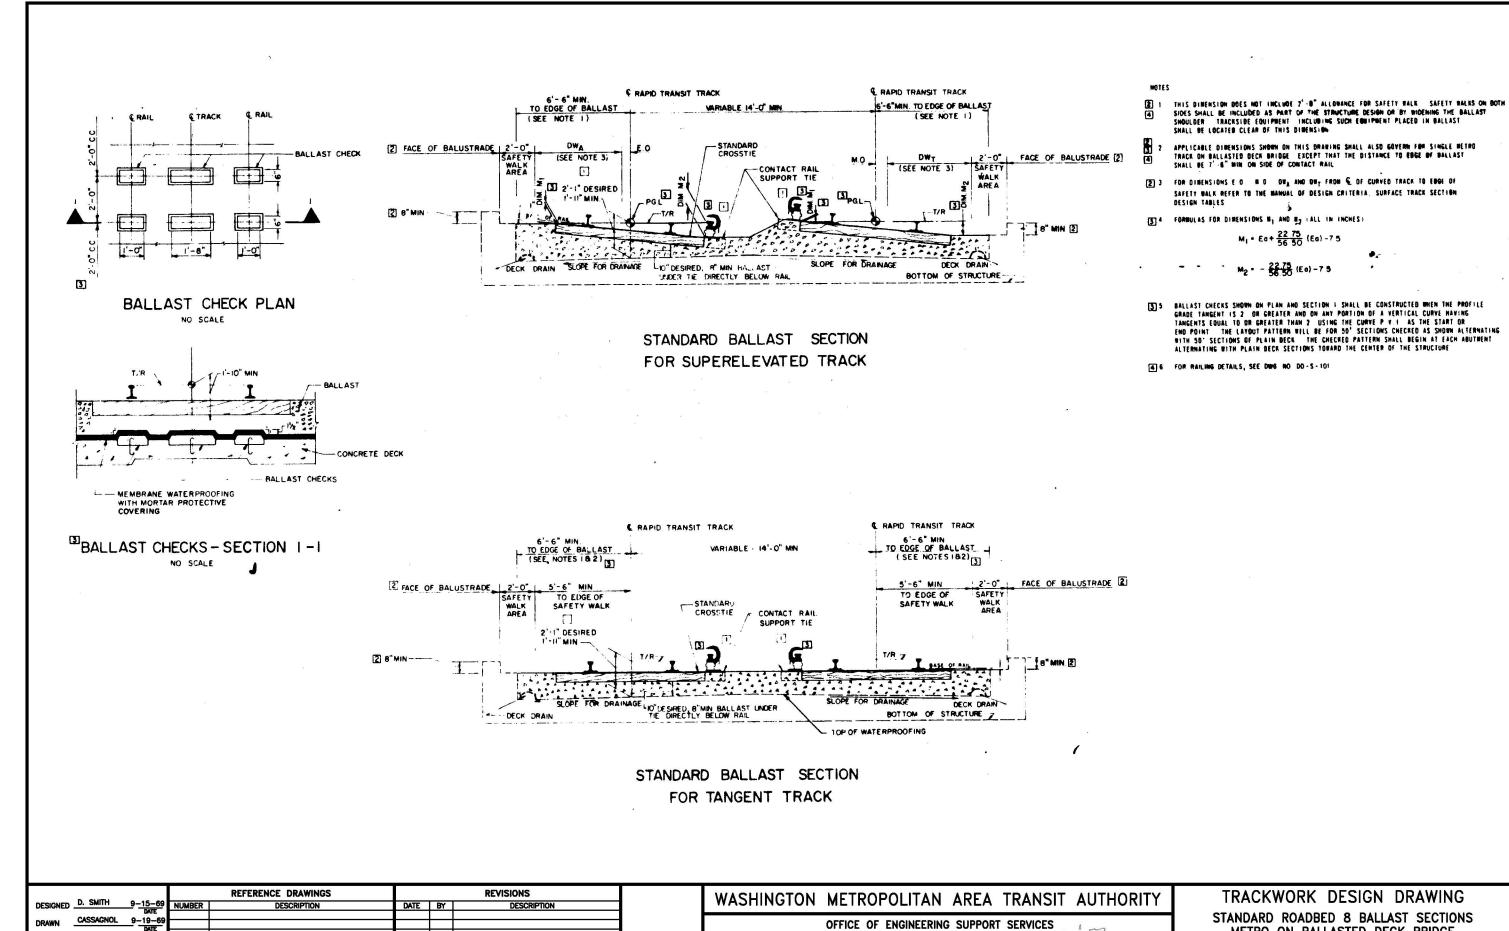

CHECKED

TRACKWORK DESIGN DRAWING STANDARD ROADBED 8 BALLAST SECTIONS METRO ON BALLASTED DECK BRIDGE

DD-TW-115


10/2007


10/2007


APPROVED


SUBMITTED


M1 . Ea + 22 75 (Ea) -7 5

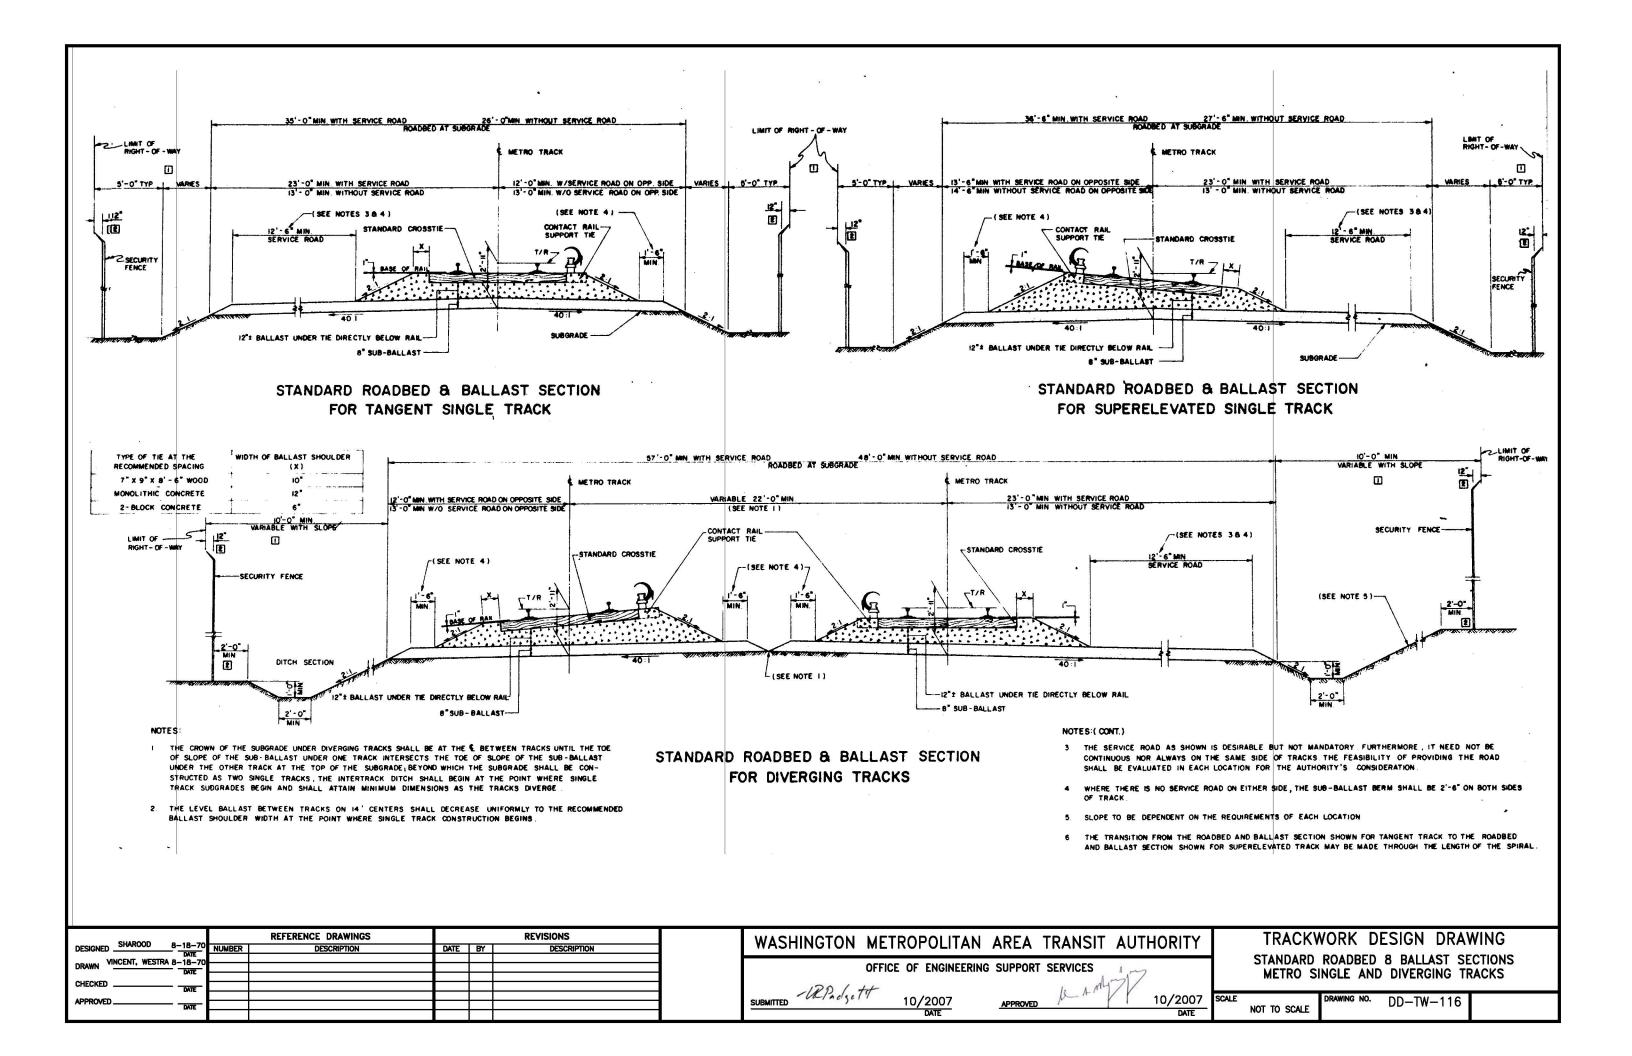


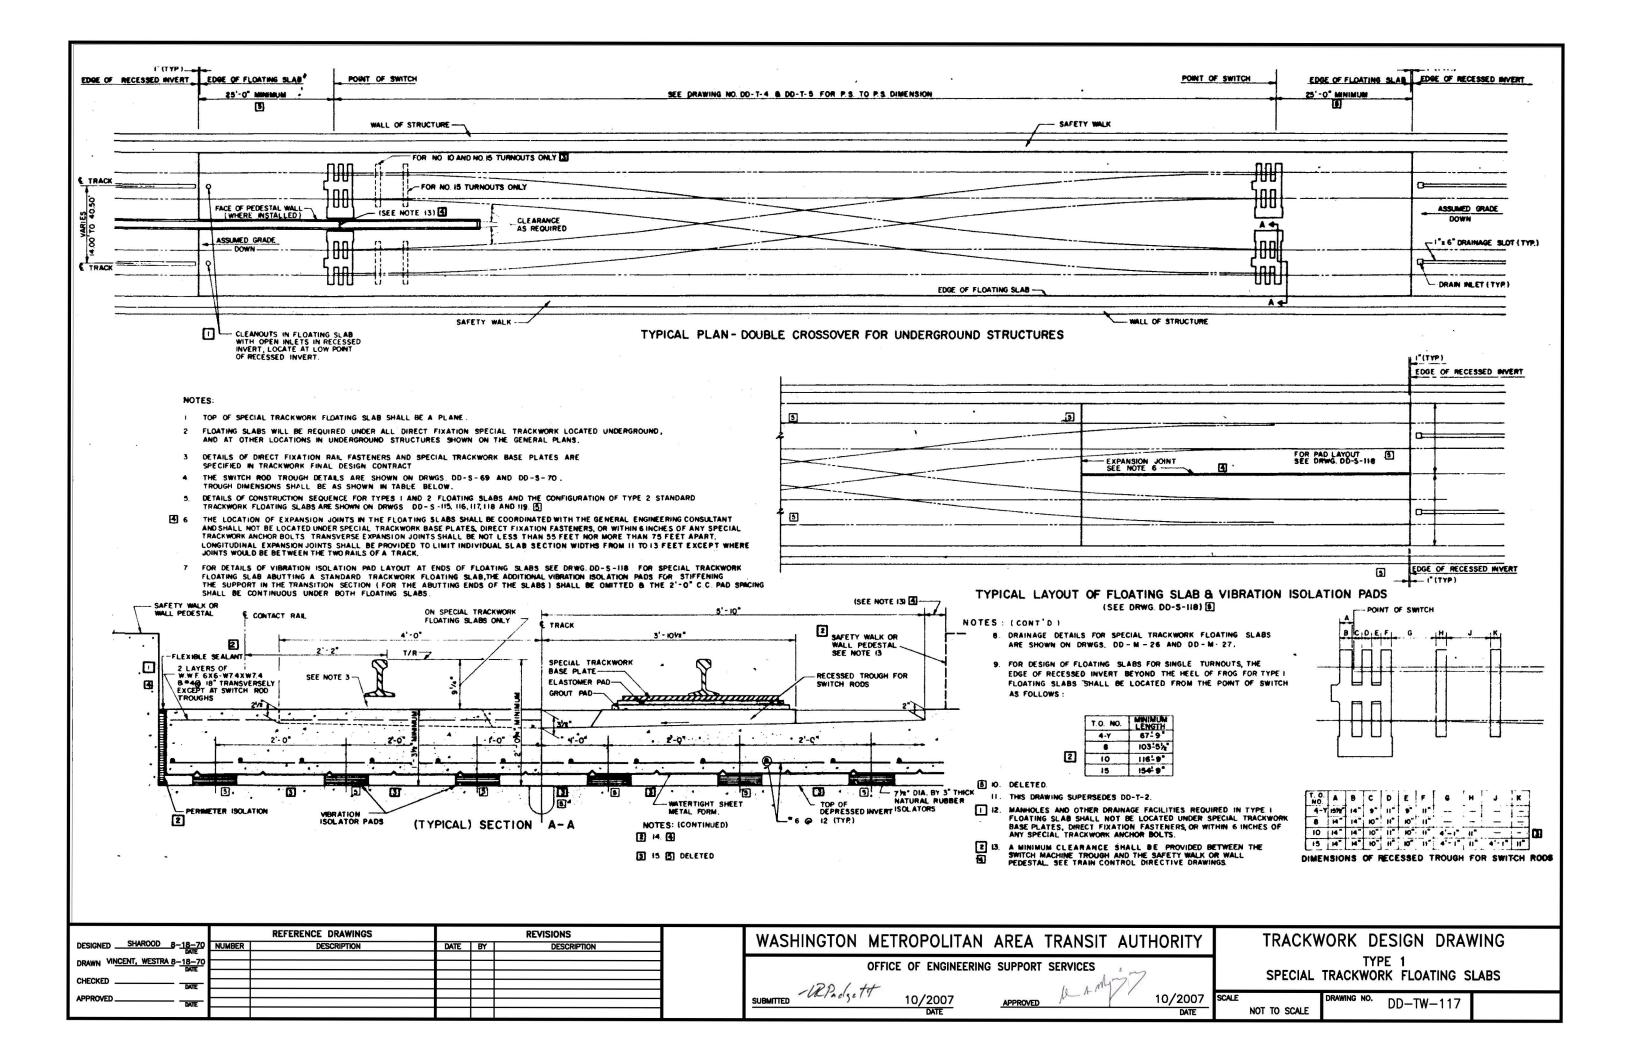


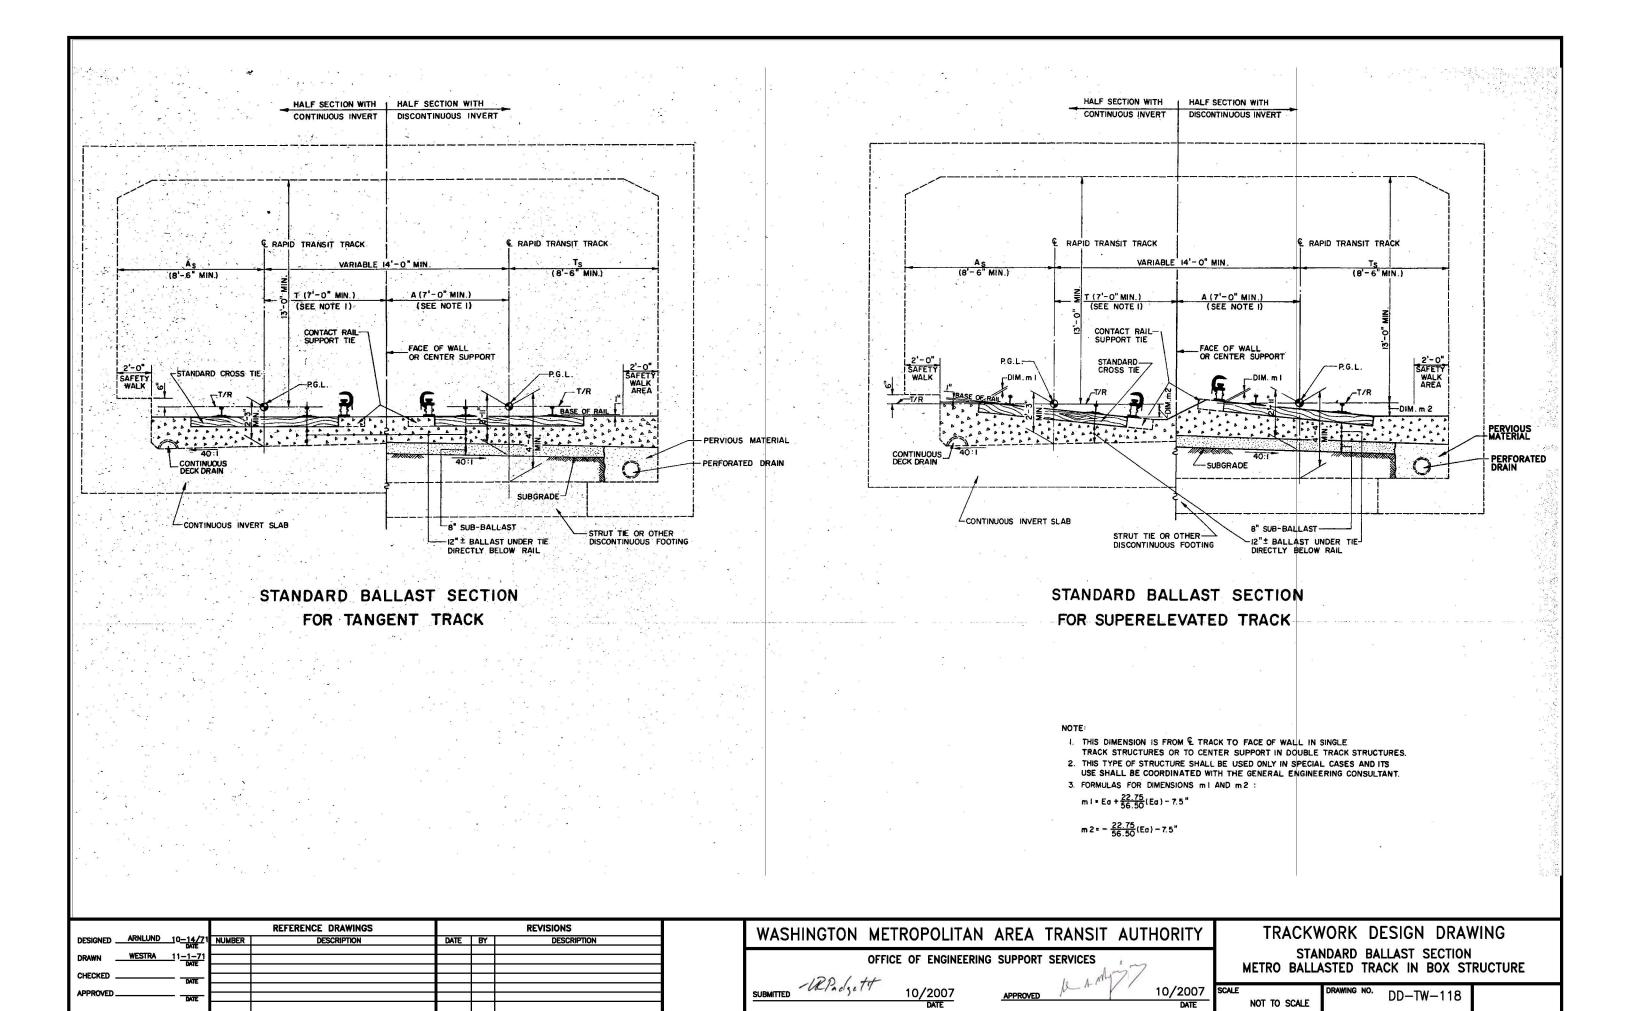


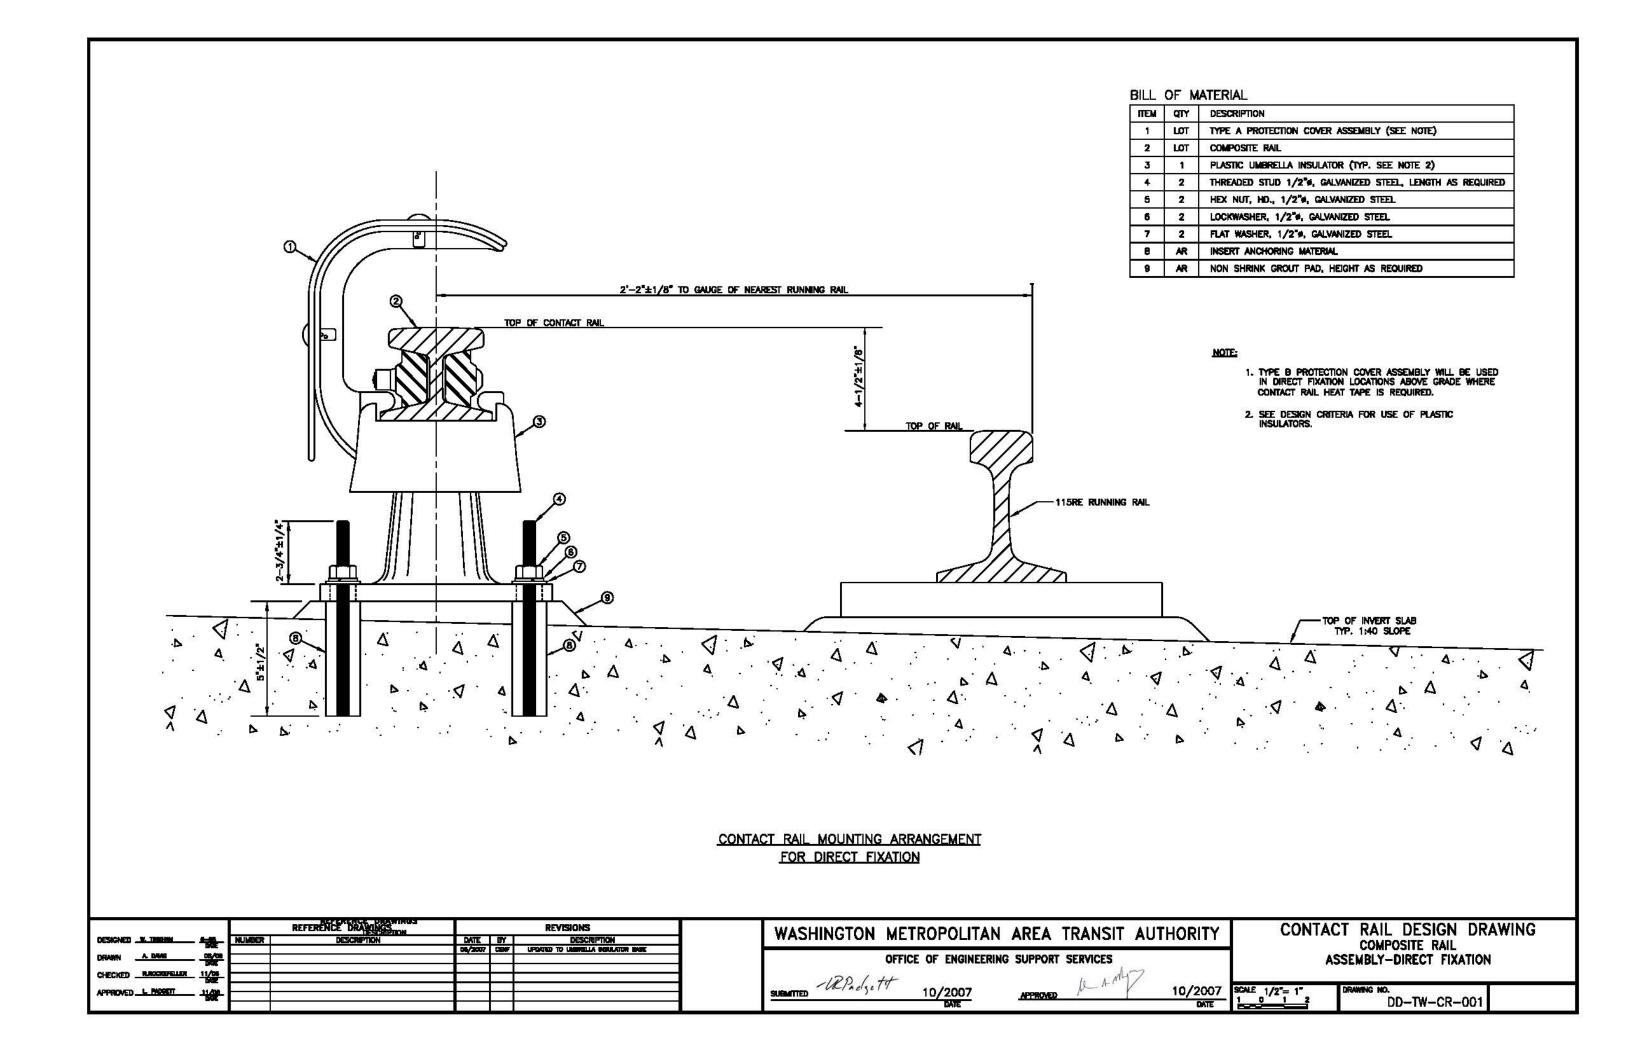


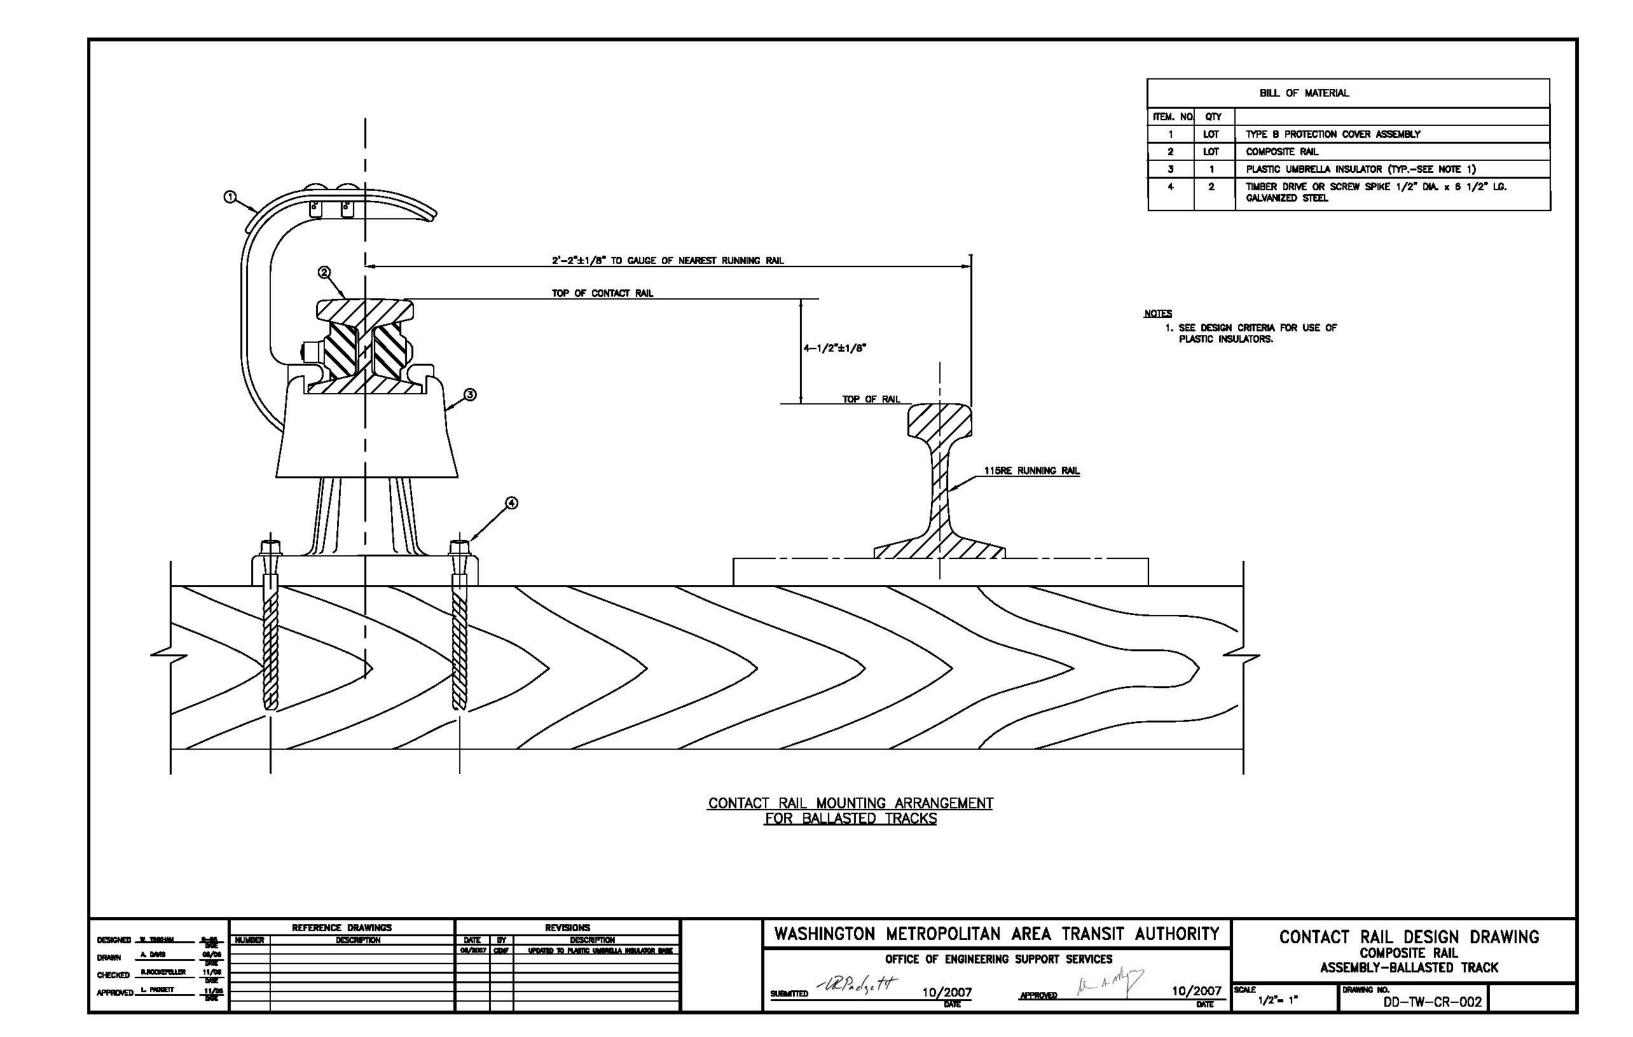


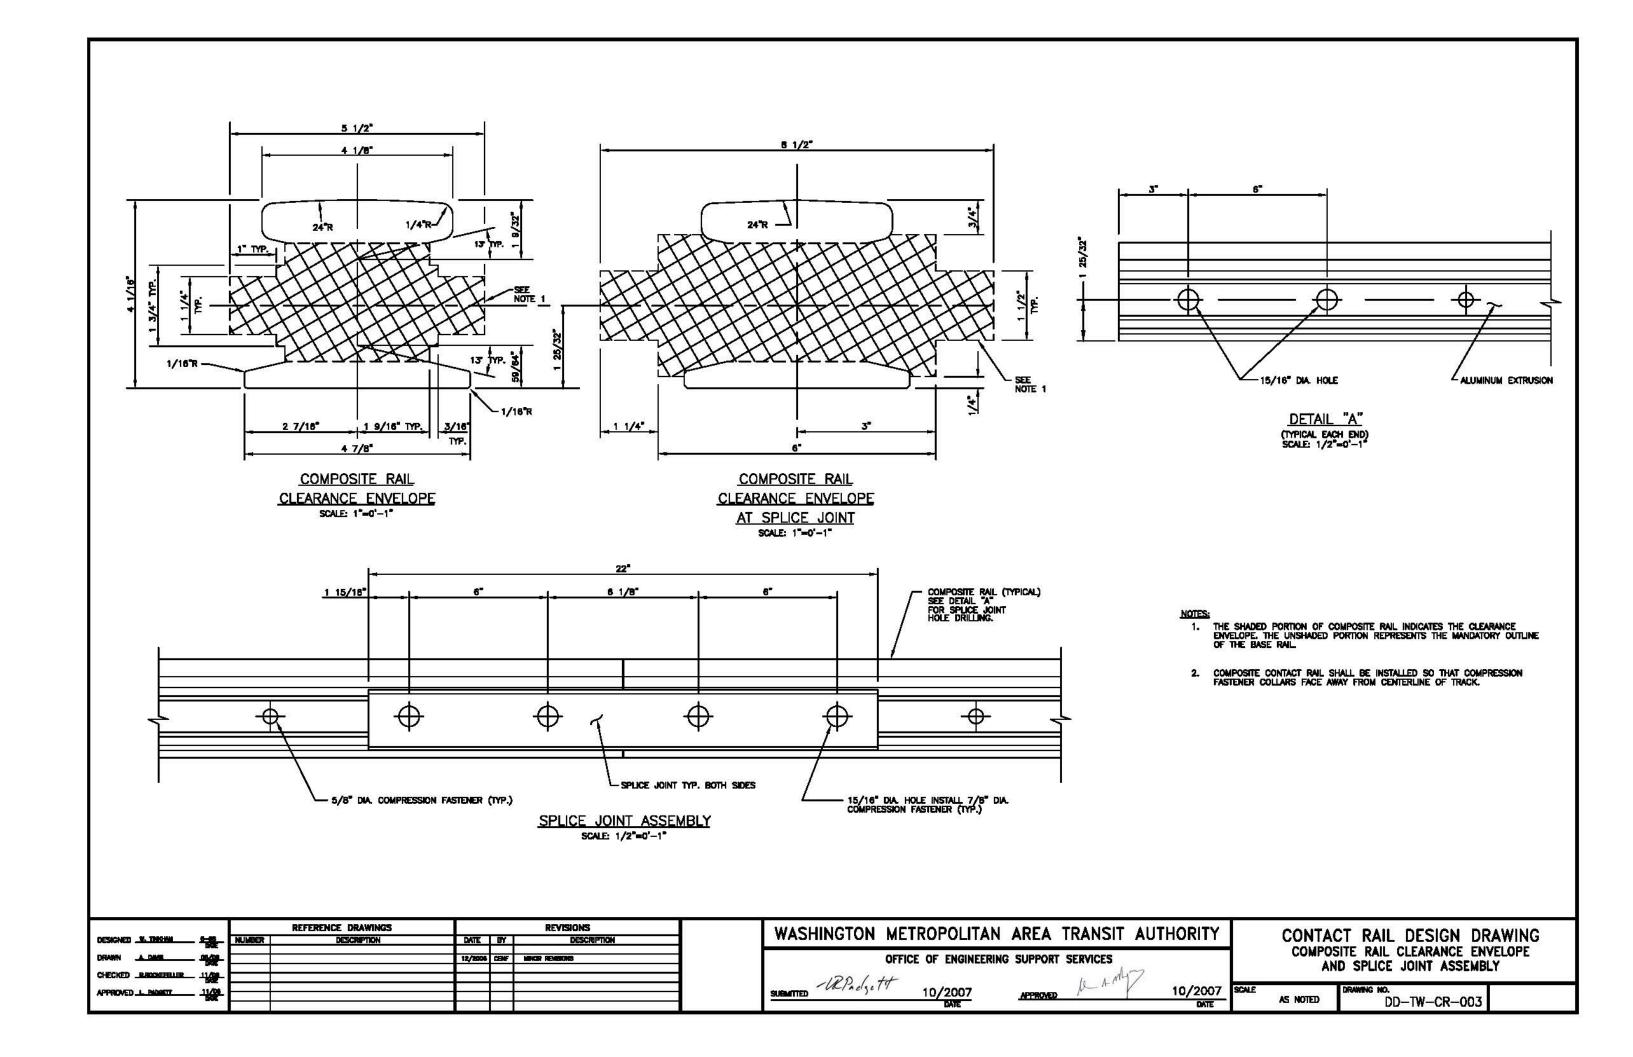


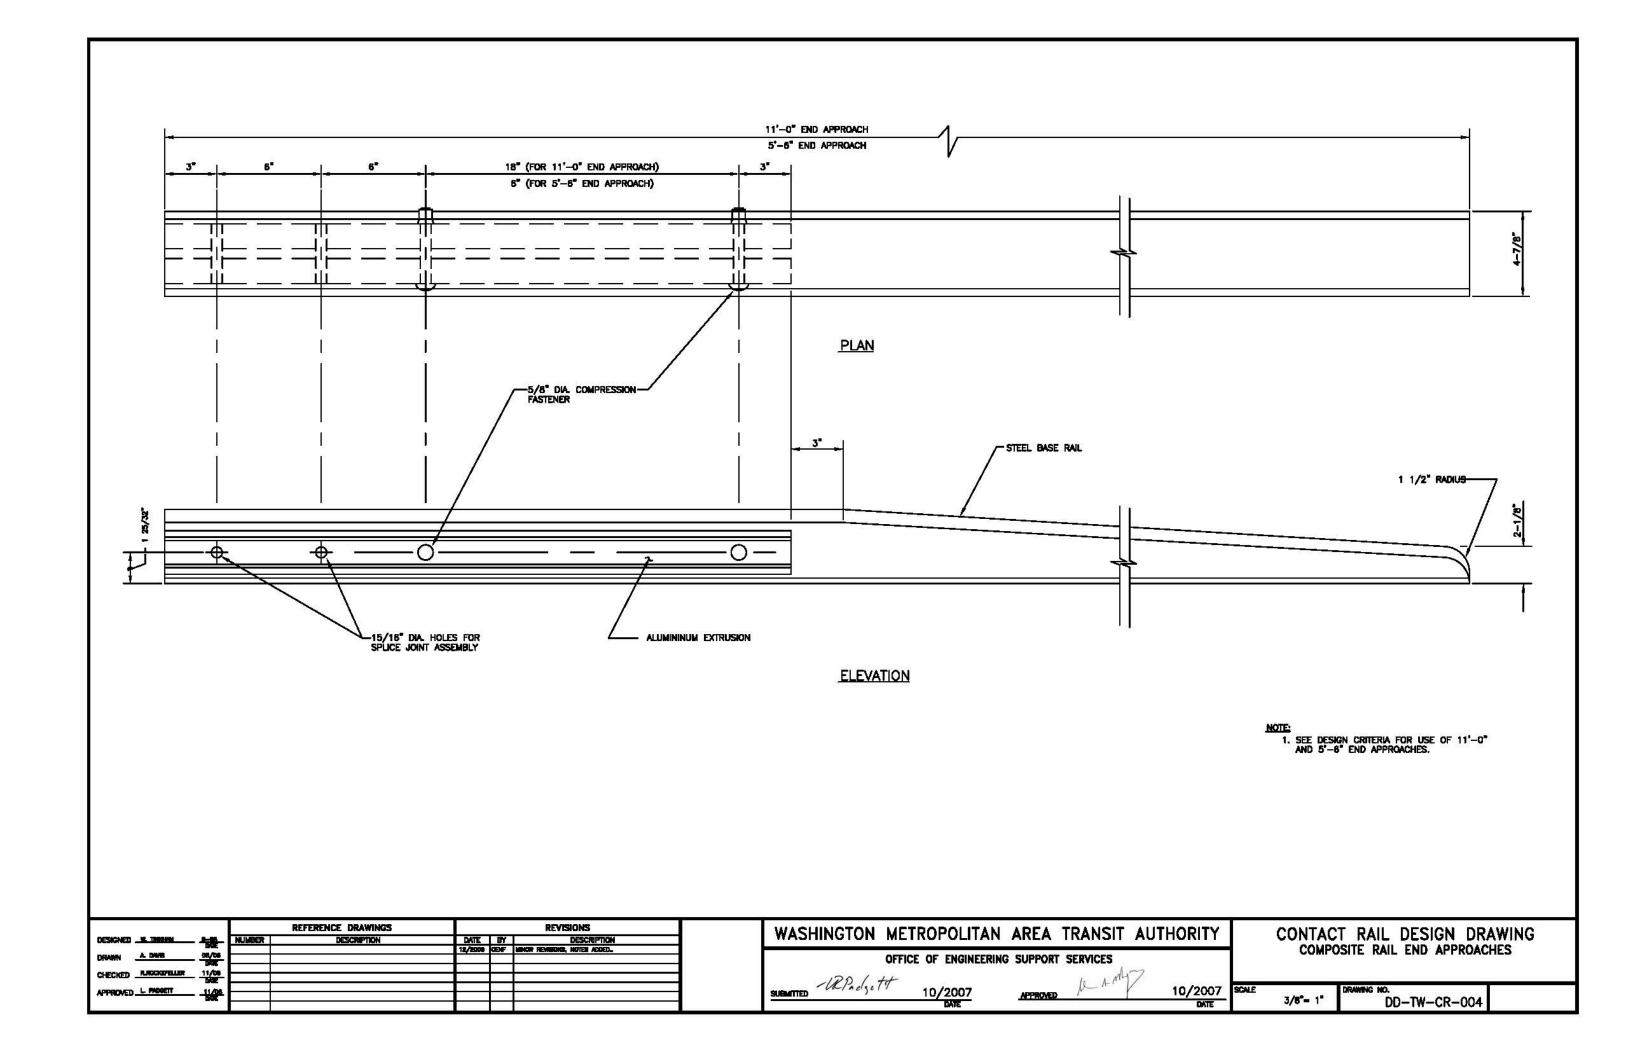


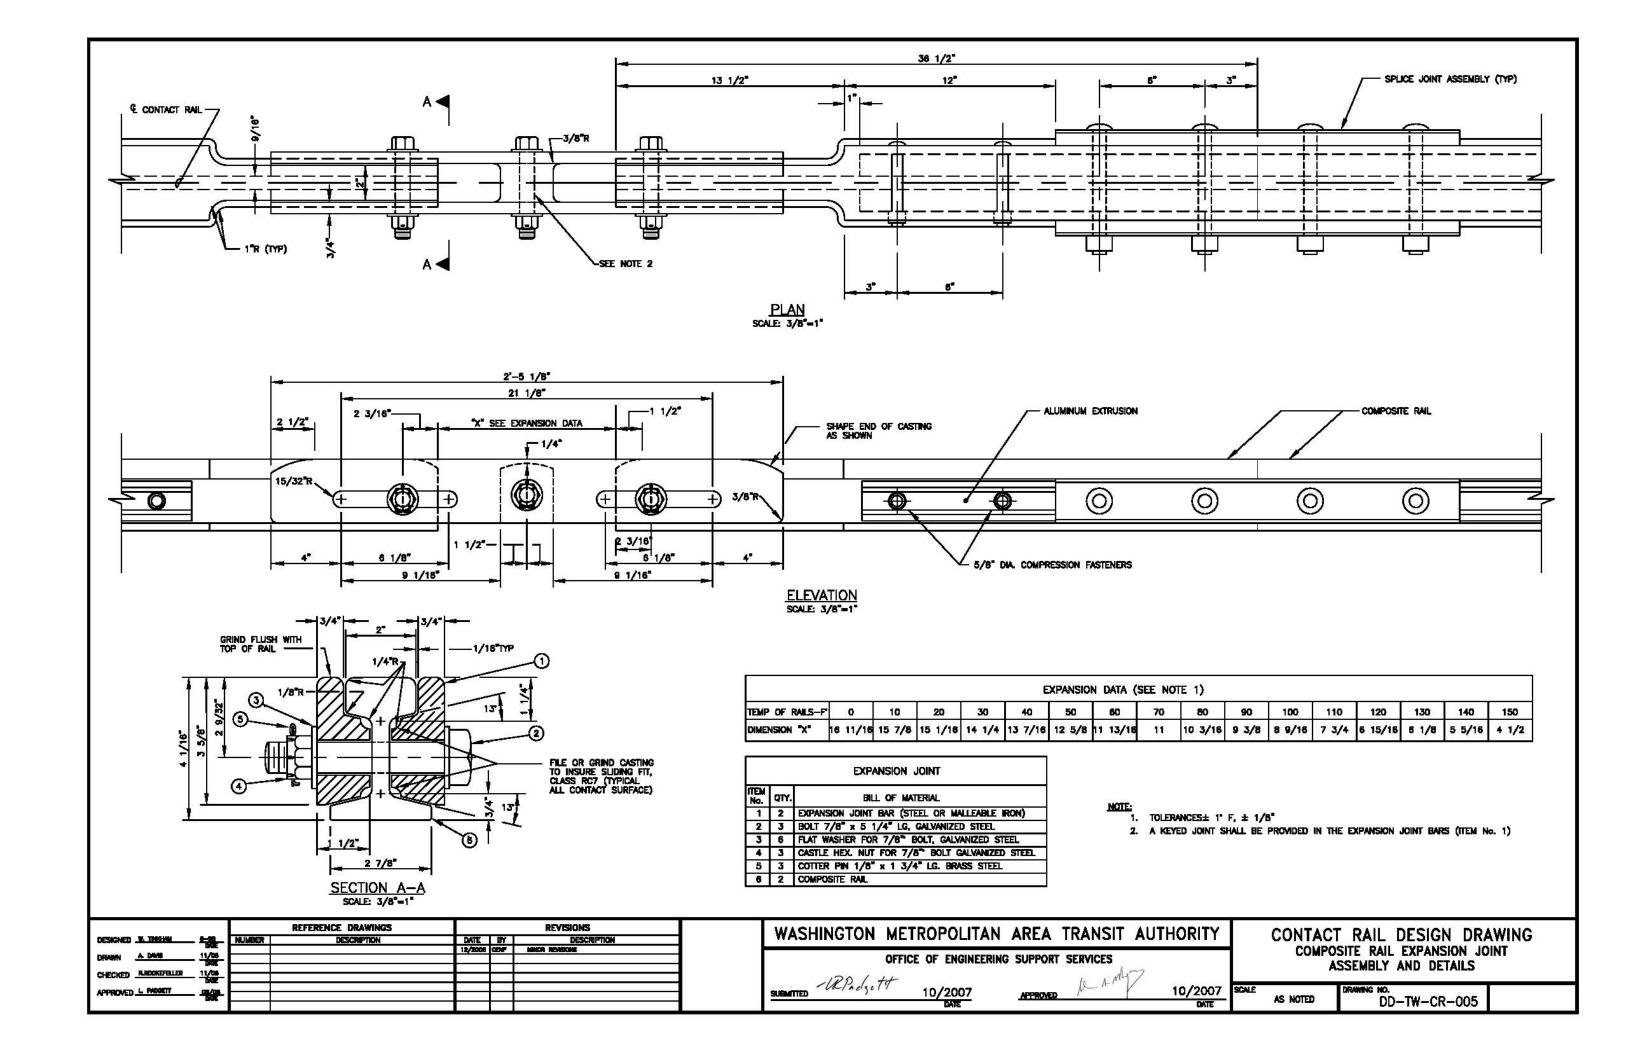

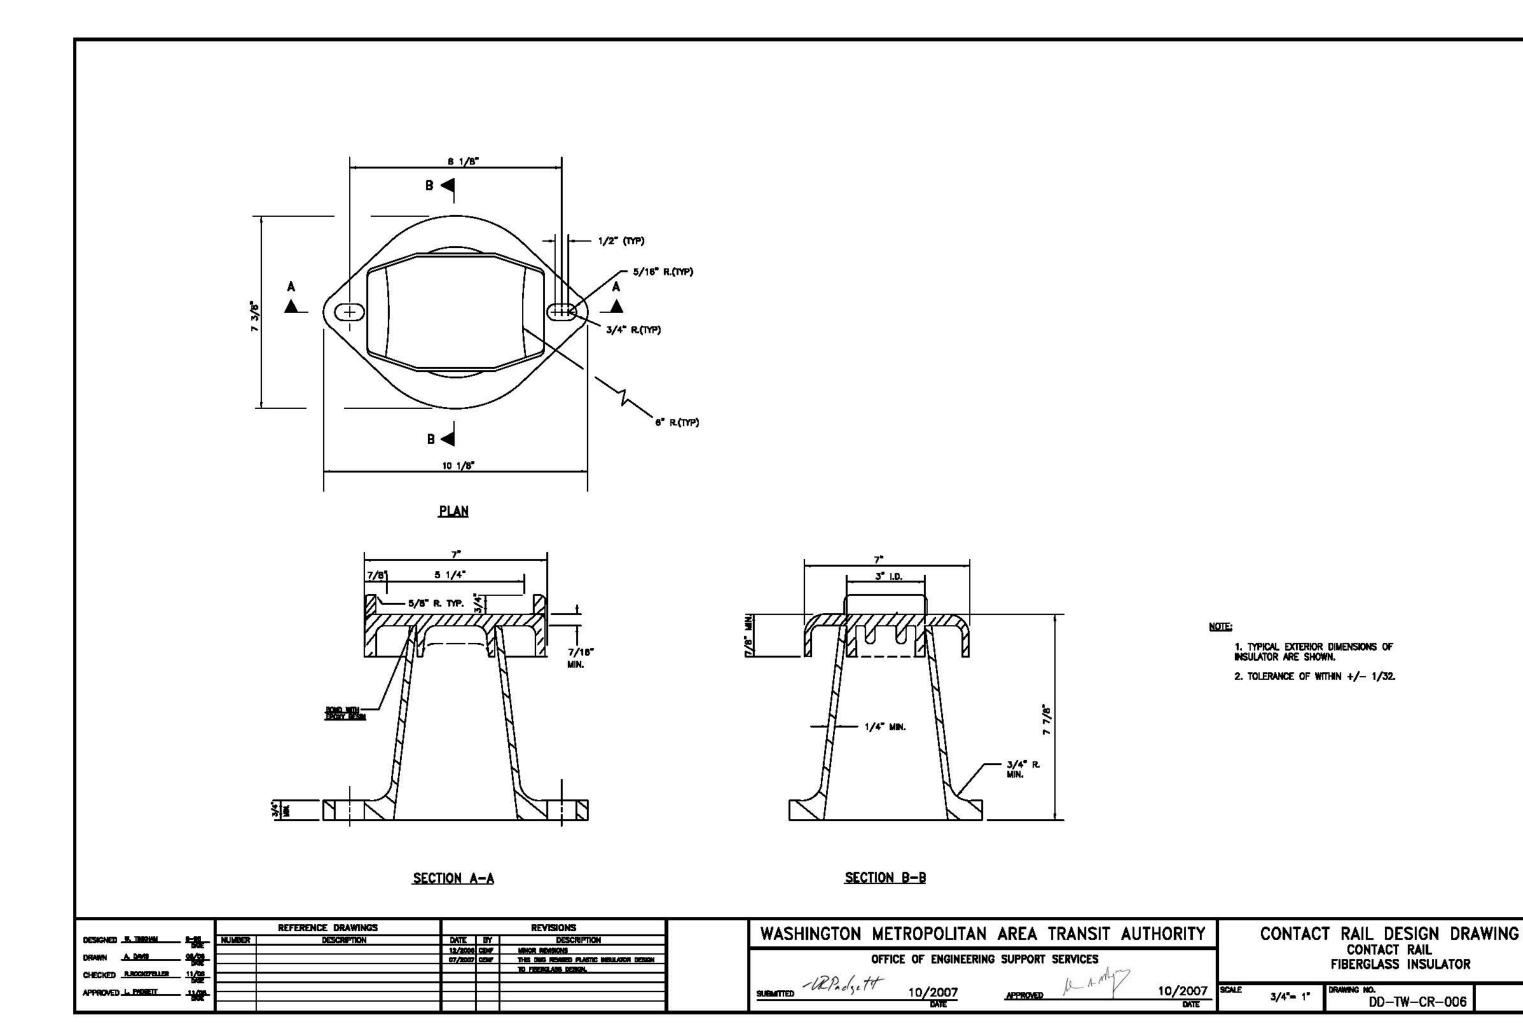

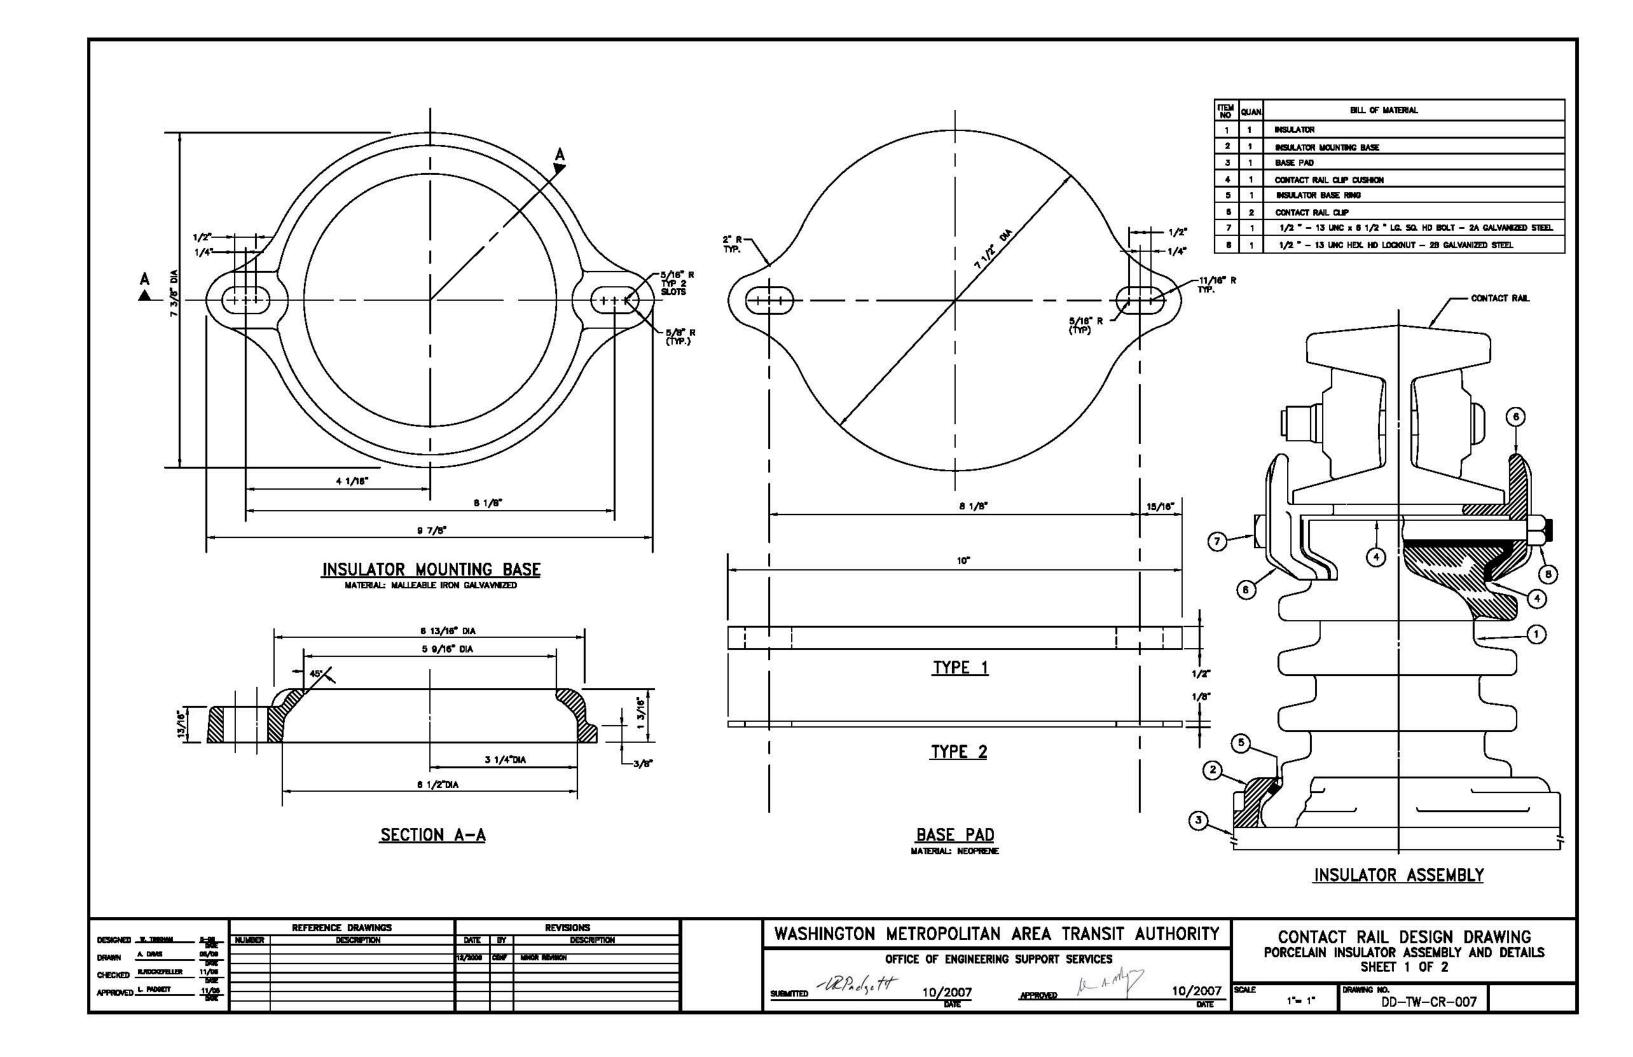


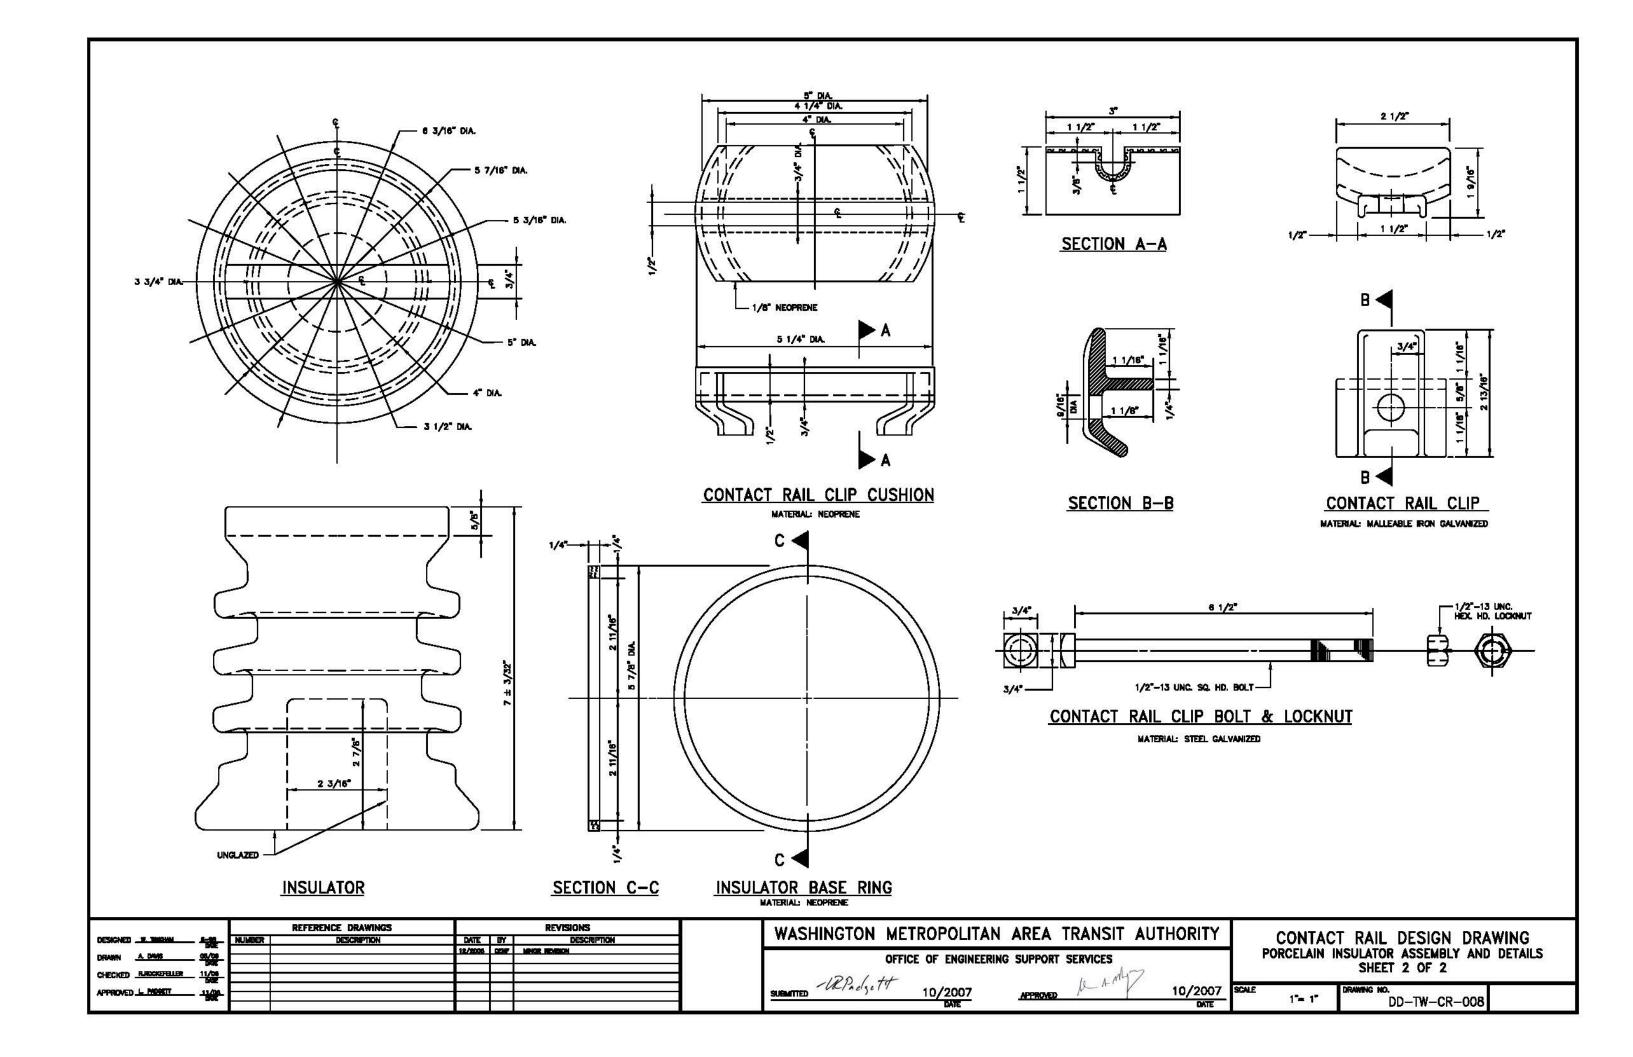

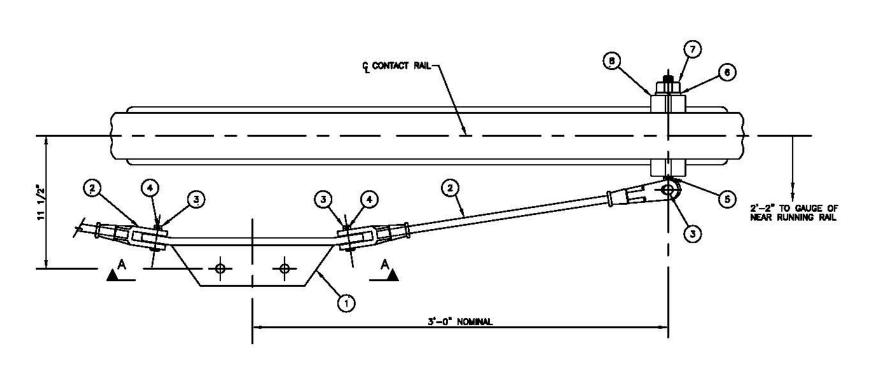



PLAN OF ASSEMBLY
SCALE: 1/4"= 1"

ASSEMBLY DESCRIPTIONS (SEE SECTION A-A)
ASSEMBLY No.1 CONTACT RAIL ANCHOR FOR TIMBER TIE
ASSEMBLY No.2 CONTACT RAIL ANCHOR FOR DIRECT FIXATION

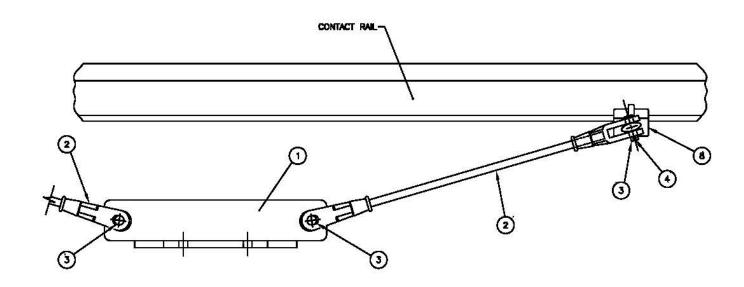

ELEVATION OF ASSEMBLY
SCALE: 1/4"= 1"

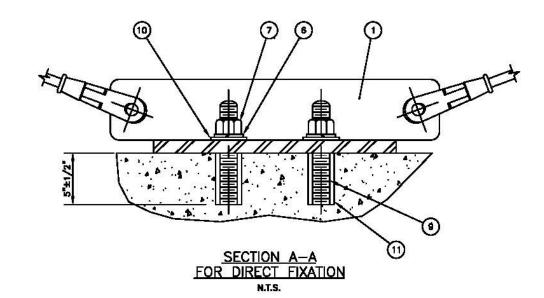

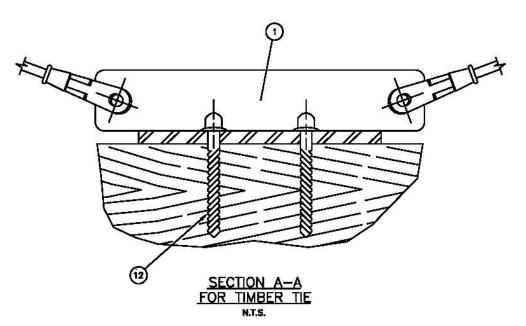

QUANTITY ITEM ASSY-1 ASSY-2 No.						
		No.	BILL OF MATERIAL			
1	1	1	BRACKET GALVANIZED STEEL			
2	2	2	CLEVIS ASSEMBLY			
4	4	3	CLEVIS PIN, .750" DIA.x2-1/8" LONG GALVANIZED STEEL			
4	4	4	COTTER PIN, .125" DIA.x1.0" LONG BRASS			
2	2	5	SHOULDER EYE BOLT, 3/4" DIA. GALVANIZED STEEL			
2	4	6	LOCKWASHER, 3/4" DIA. GALVANIZED STEEL			
2	4	7	HEX. NUT, 3/4" DIA. GALVANIZED STEEL			
4	4	8	CLAMP, MALLEABLE IRON, GALVANIZED			
-	2	9	THREADED STUD 3/4" DIA.x7-3/4" LONG GALVANIZED STEEL			
-	2	10	FLAT WASHER 3/4" DIA.x3/16" THICK GALVANIZED STEEL			
(5.78)	1	11	INSERT ANCHORING MATERIAL			
2	 3	12	WASHERHEAD DRIVE SPIKE 11/18" DIA.x6" LONG GALVANIZED STEEL			


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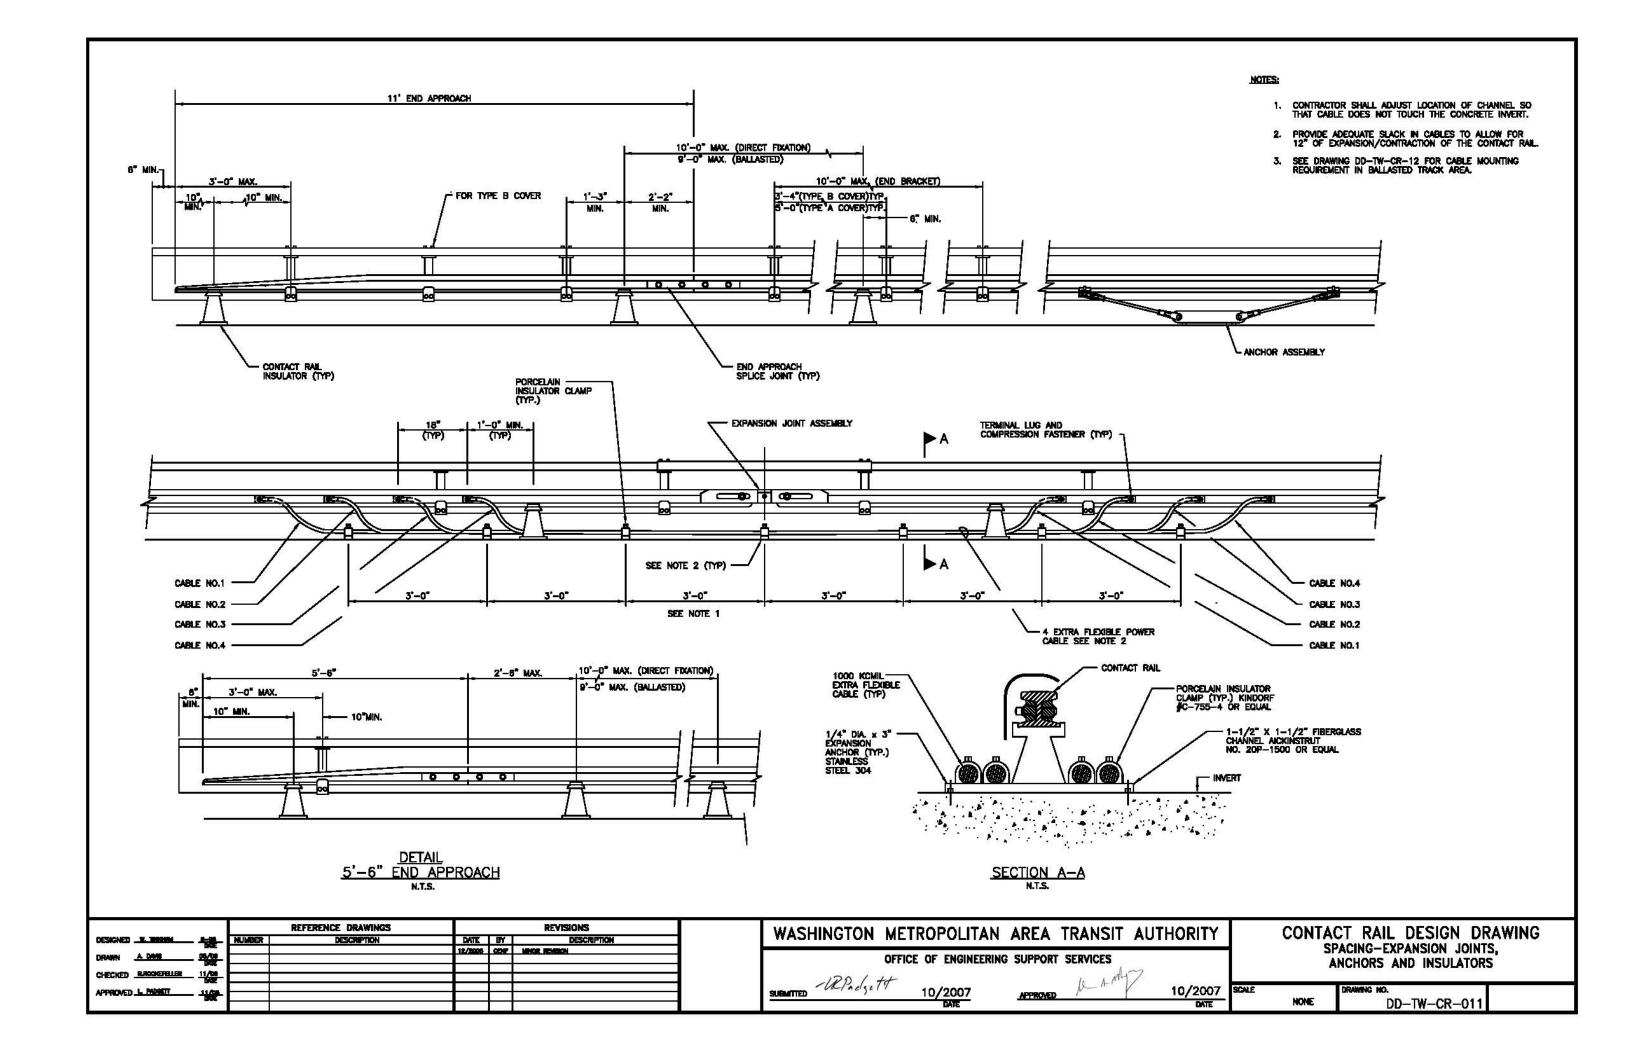
WASHINGTON	METRO	POLITAN	AREA	TRANSIT	AUTHORITY
	OFFICE OF	ENGINEERING	SUPPORT	SERVICES	


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Sugmitted	-WPadgett	10/2007	APPROVED	pe A MI	10/2007
		DATE			DATE


CONT	ACT	RAIL	DE	ESIG	GN	DF	RAWIN	G
ANCHOR	ASSI	EMBLY	DE	TAIL	S	AND	SECTIO	NS
		SHEET	٦ 1	OF	2			


2.5	SCALE AS NOTEI	DD-TW-CR-009	




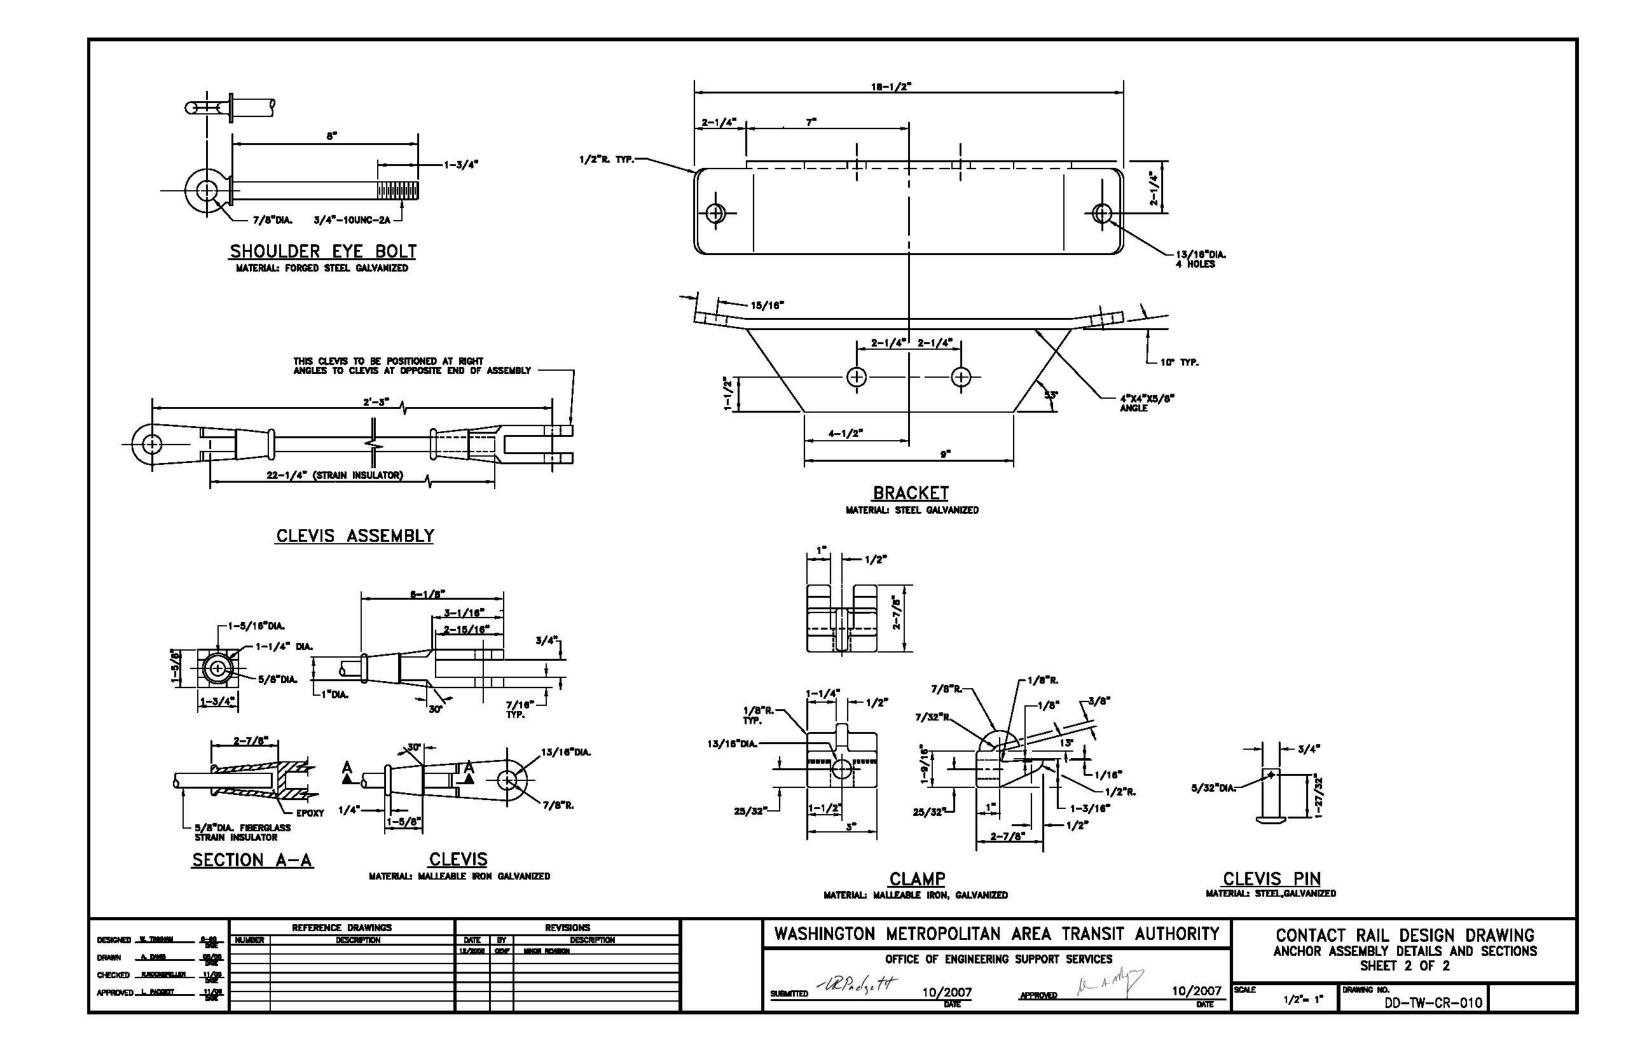


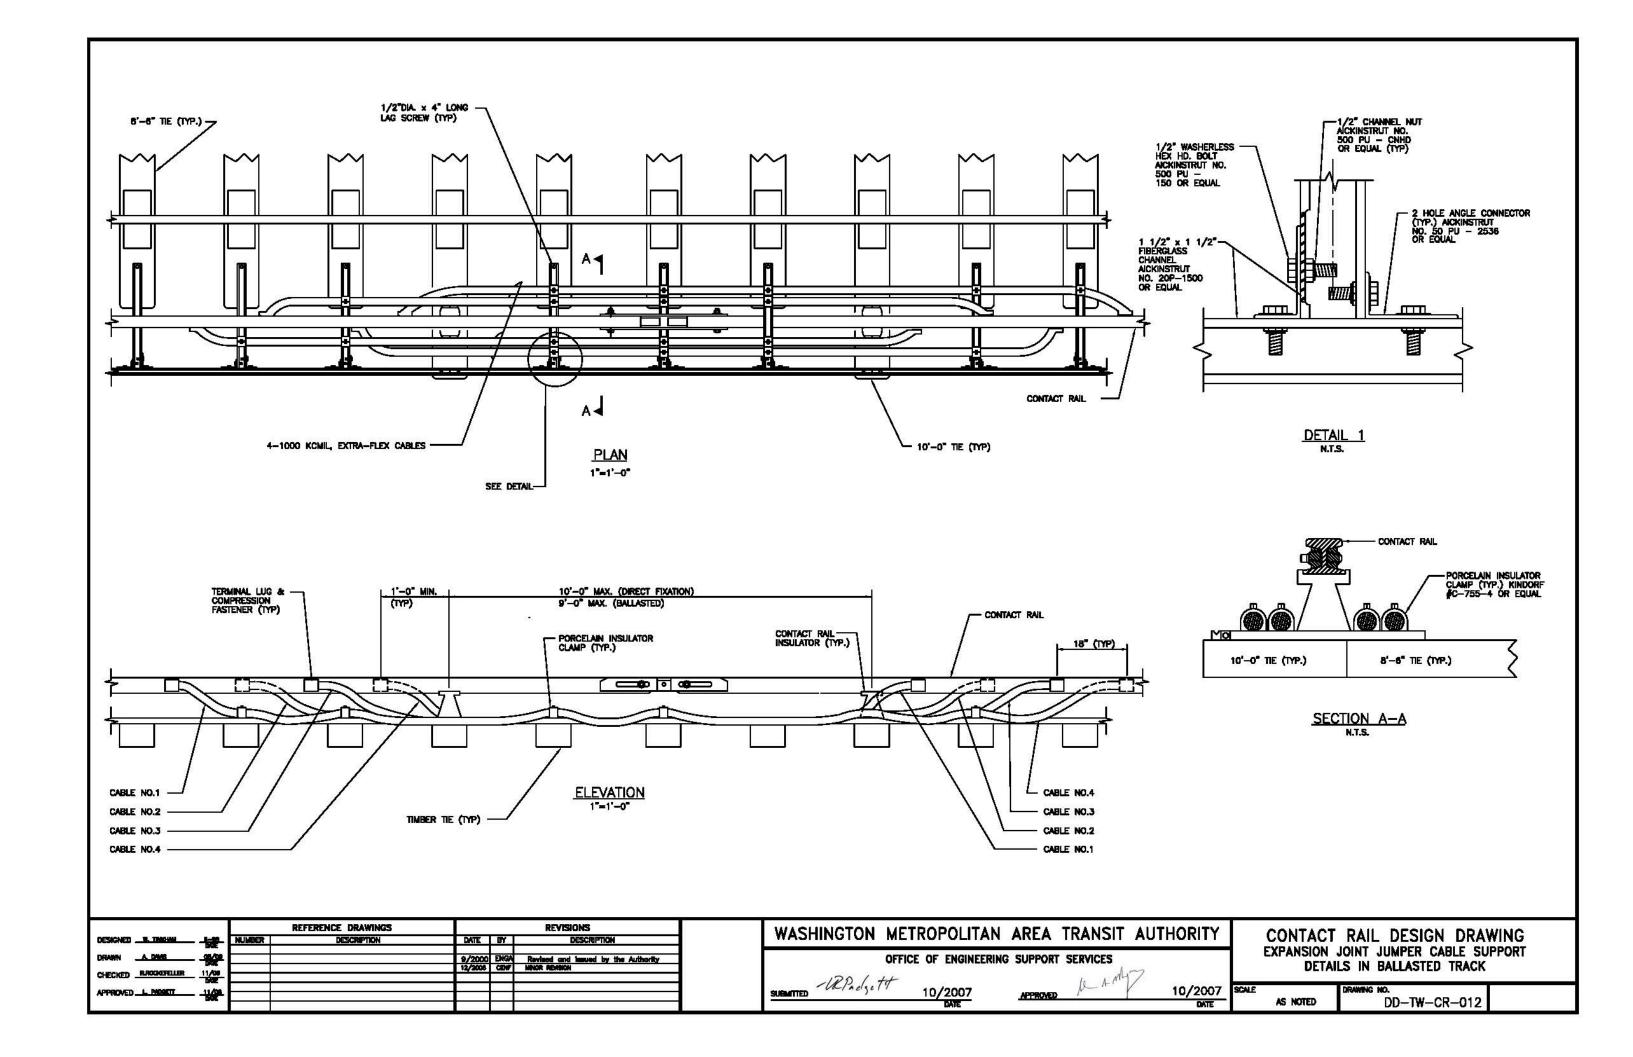


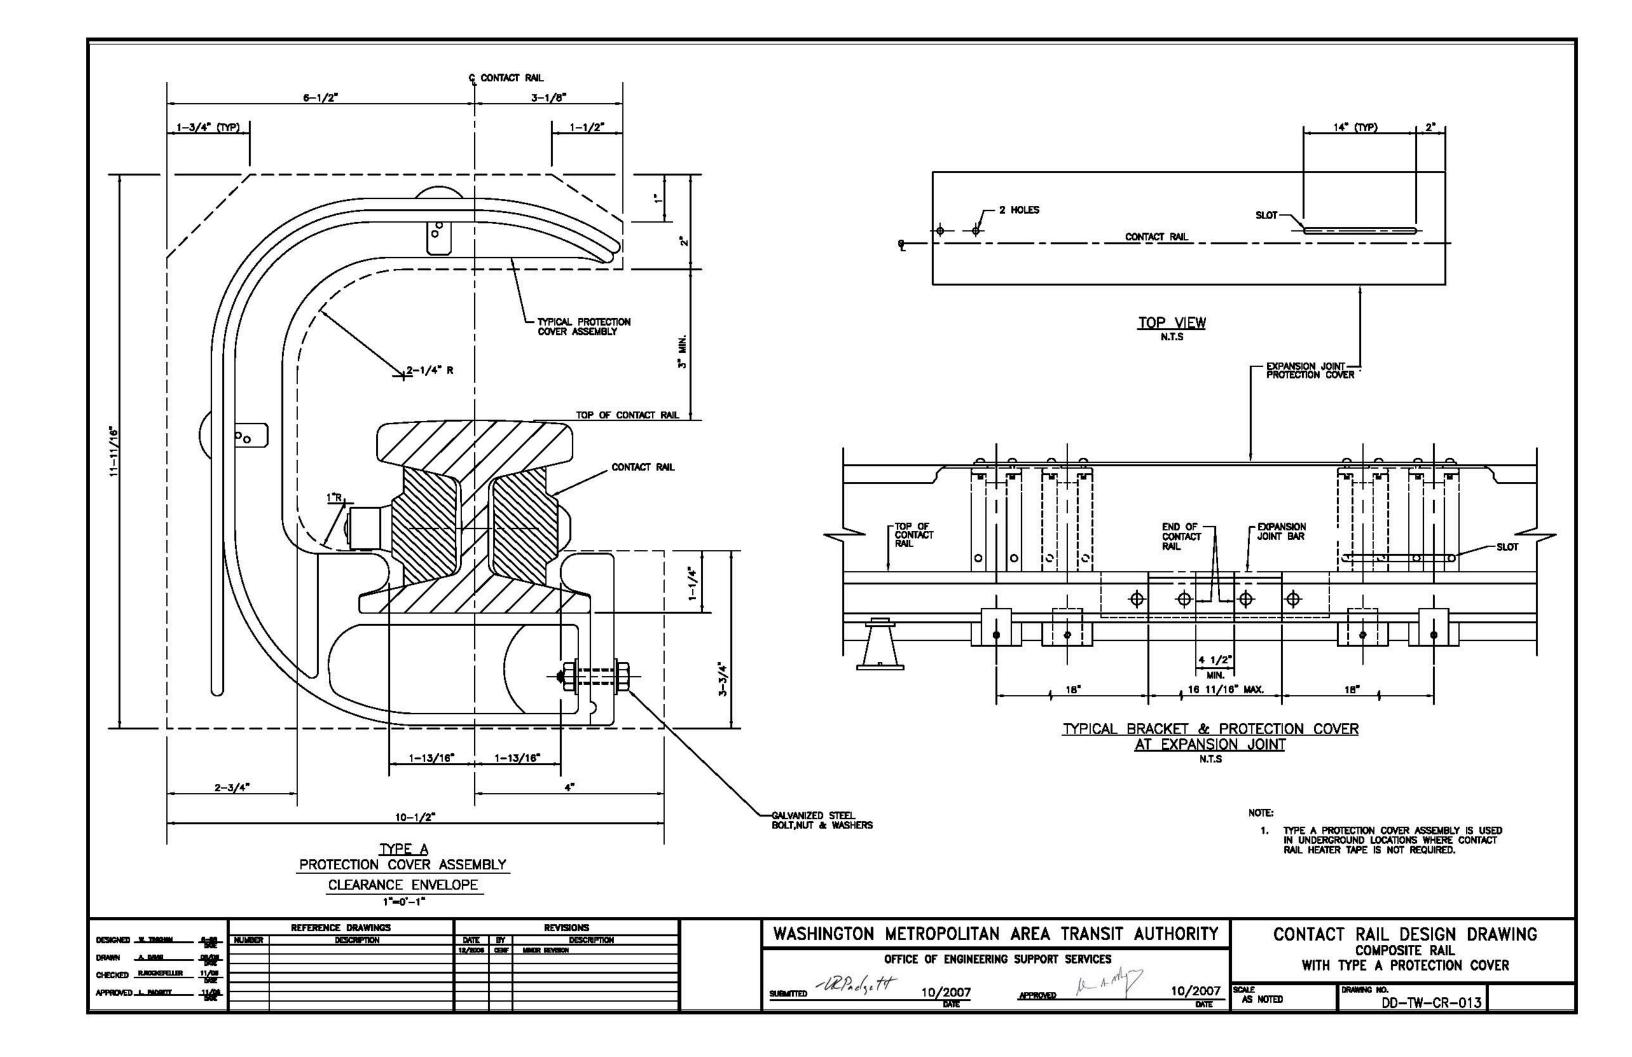


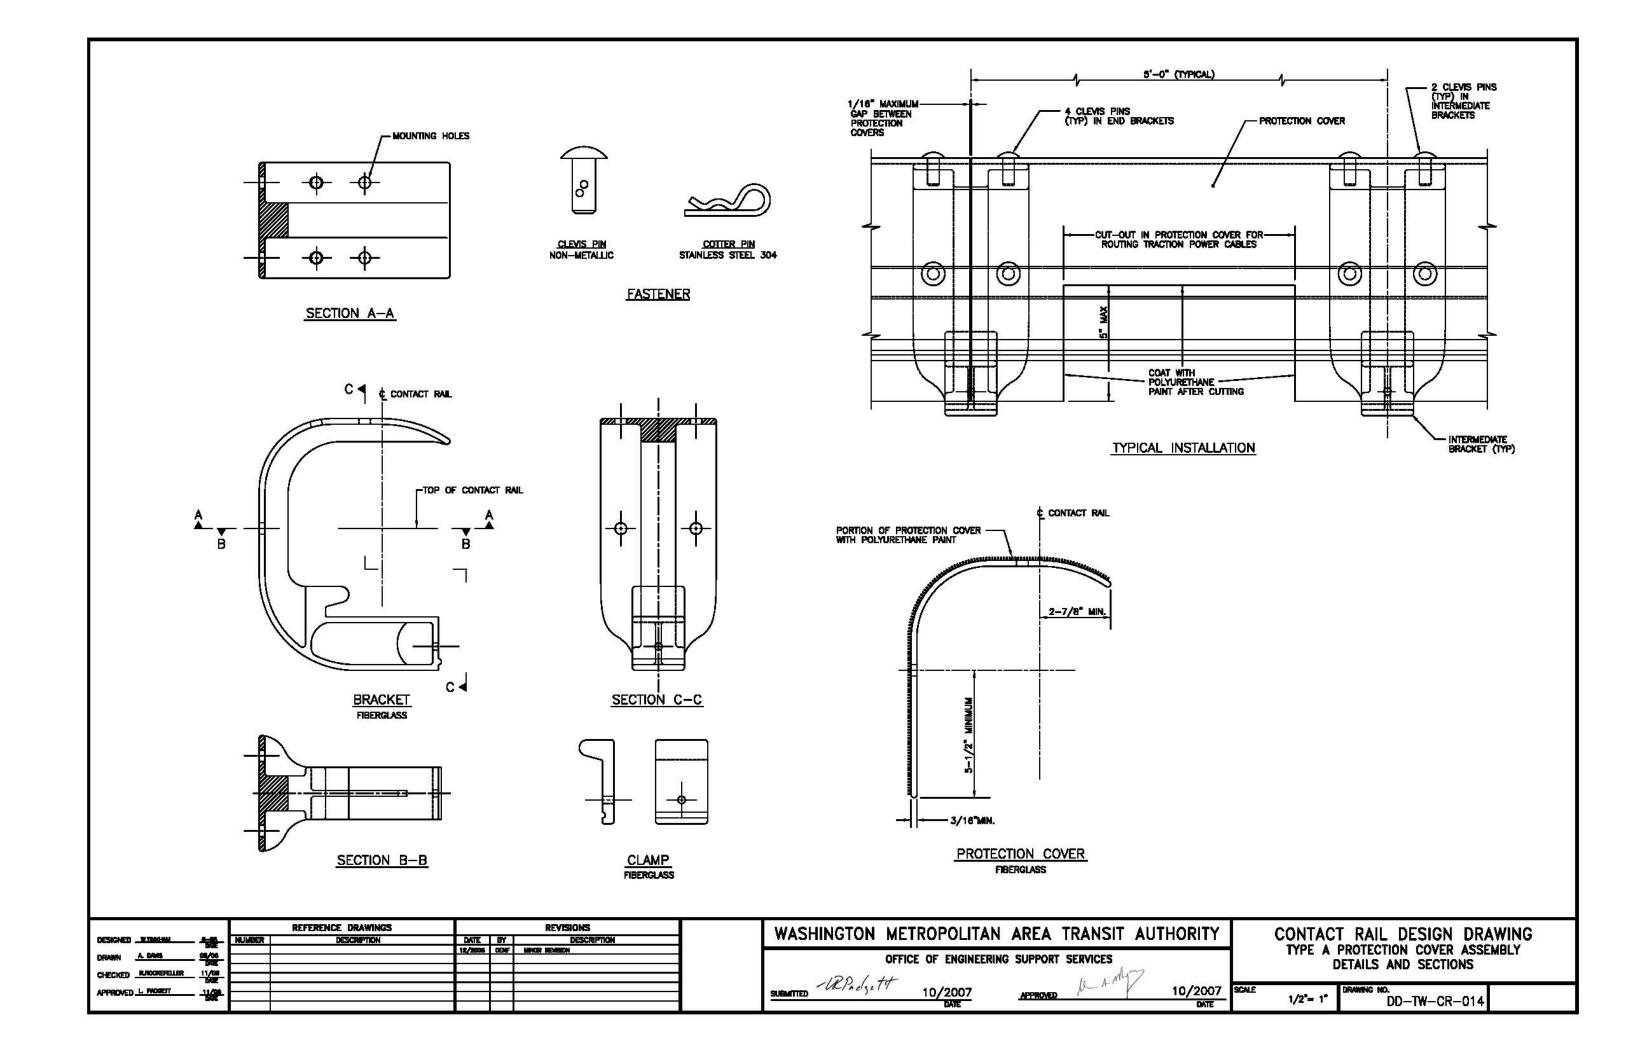

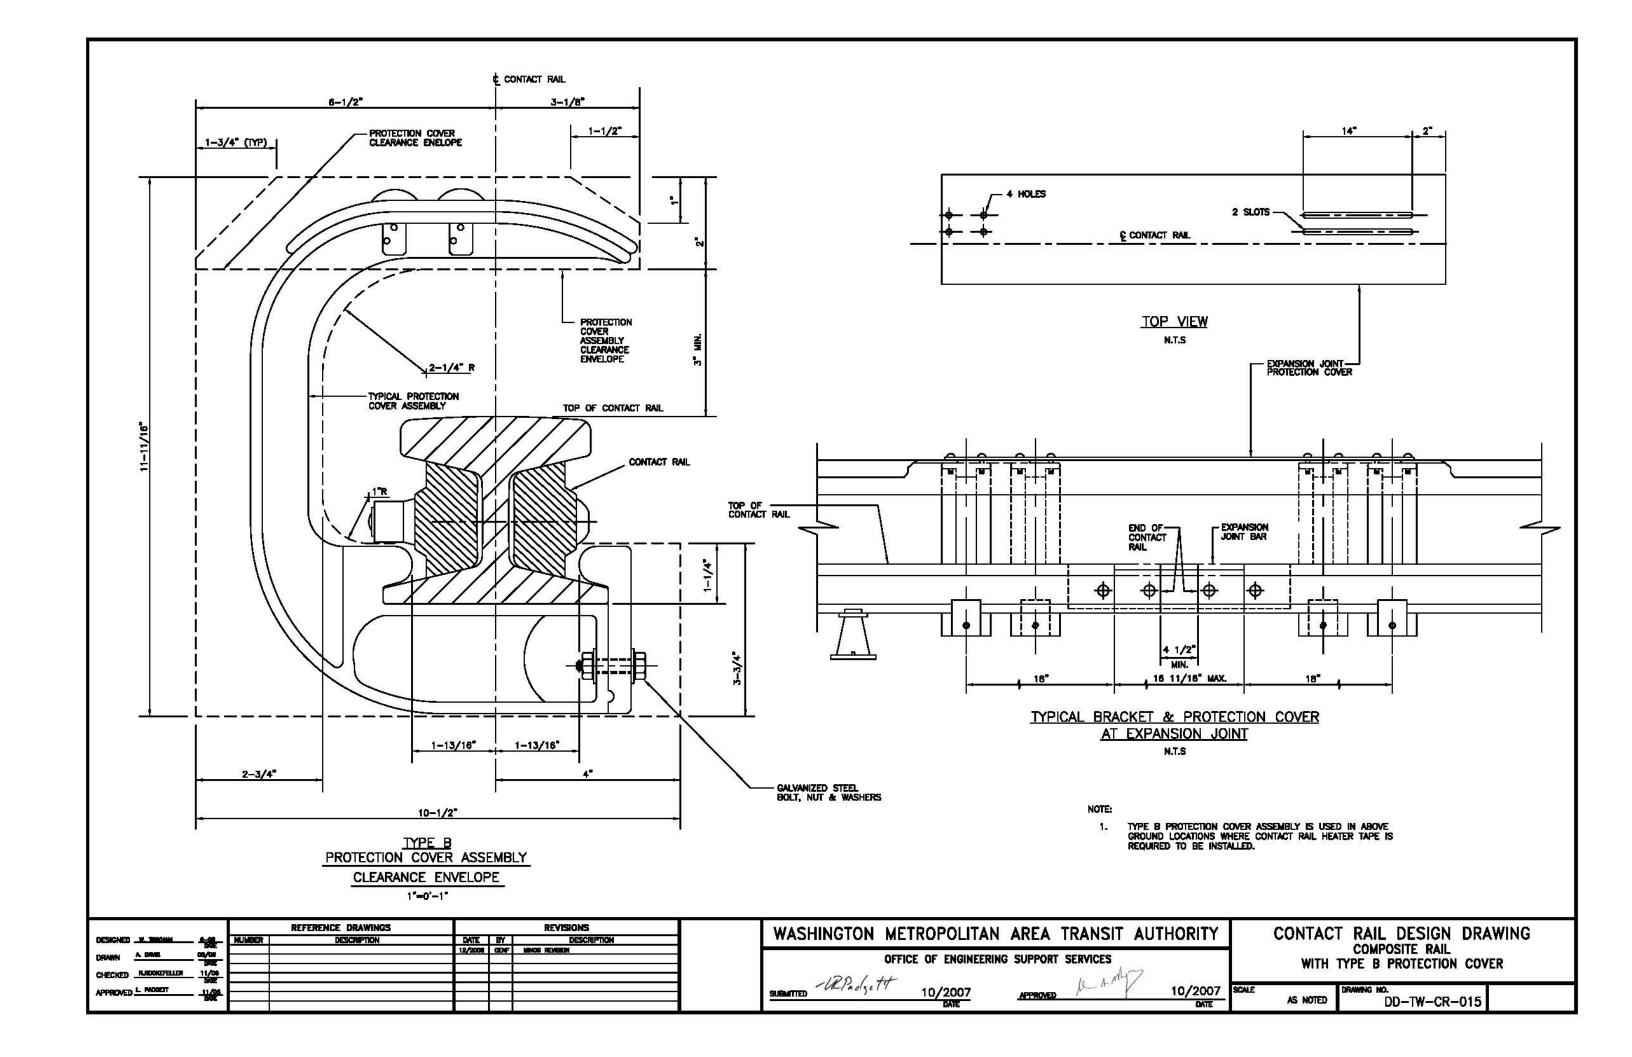


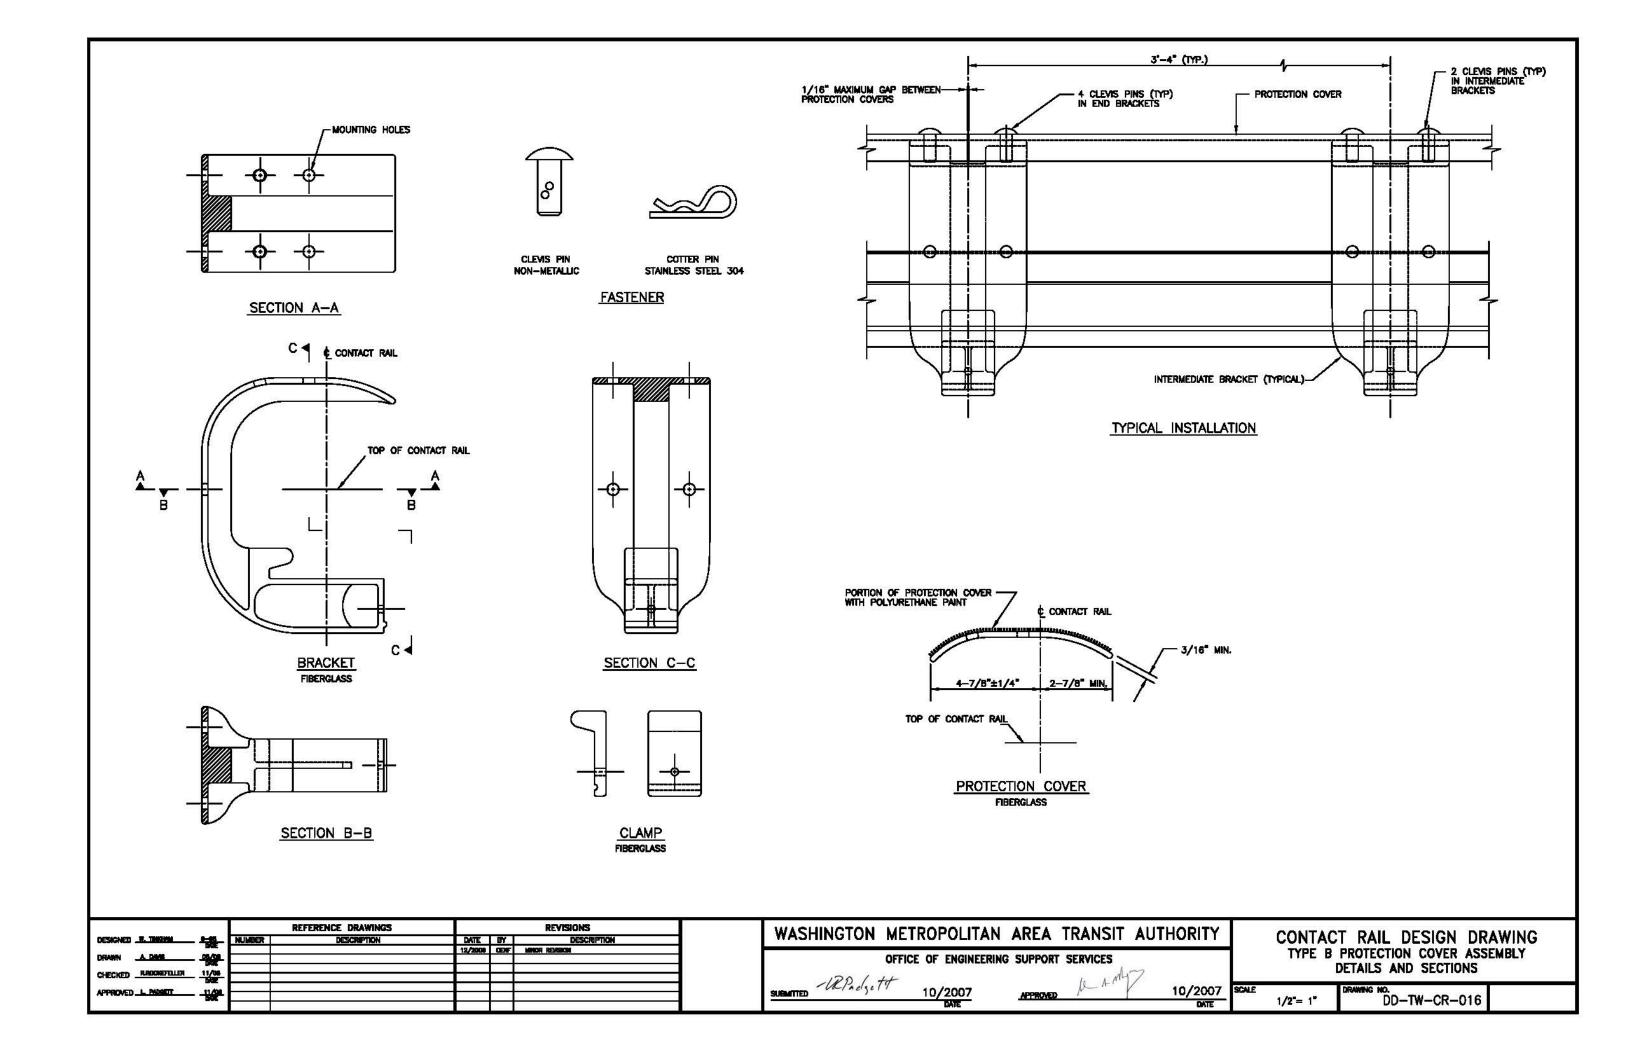


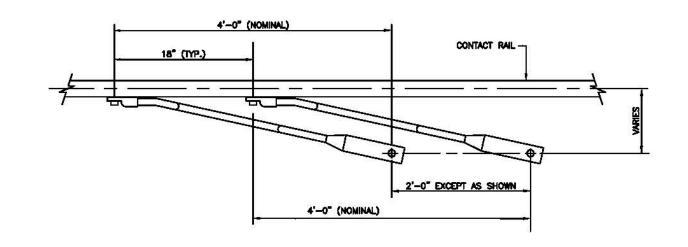

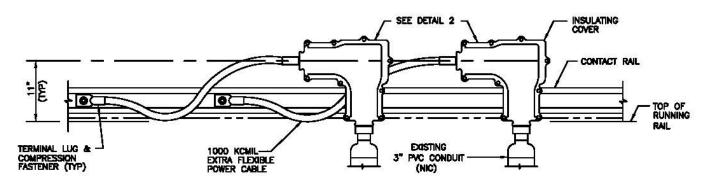

DETAIL "1" TYPICAL CONNECTION FOR COMPOSITE CONTACT RAIL

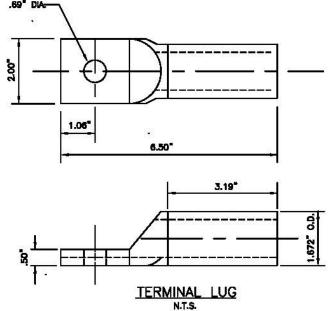

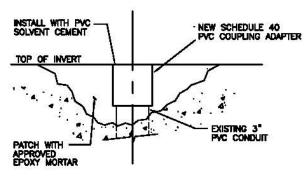

METHOD FOR REPAIRING **BROKEN TRACTION POWER CONDUIT** SCALE: N.T.S.

	R	EFERENCE DRAWINGS			REVISIONS
ESIGNEDILTIMONU	NUMBER	DESCRIPTION	DATE	BY	DESCRIPTION
revised and reserve 1879/200			12/2008	CENT	MINOR REVISIONS
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					Û
HECKED NACKOTELLER 11/08					
PROPRIET L PROSETT 11/06	K K				4
- 100E					
PPROVED L PROSETT 11/78					

WASHINGT	ON MET	ROPOLITAN	AREA	TRANSIT	AUTHORITY
	OFFICE	OF ENGINEERING	SUPPORT	SERVICES	
SUBMITTED -UZP.	elsett	10/2007	APPROVED	be A ML	10/2007
·		DATE			DATE

	001117	HFHFHF HFHH		TE RAIL	·
	TYPICAL	CONDUIT	AND	CABLE	ARRANGEMENT
Æ	NONE	DRAWING I		-TW-CR	-017

CONTACT RAIL DESIGN DRAWING

- 1/2" BOLTS & NUTS WITH LOCKWASHERS AT EACH END

TWO-PIECE INSULATING COVER, WITH GASKET

COMPRESSION CONNECTORS

1000 KCMIL STANDARD DUTY OR EXTRA-FLEX POWER CABLE

CONDUIT SEALING BUSHING

- 3" PVC CONDUIT

CAPTIVE SCREW

- 1000 KCMIL EXTRA FLEXIBLE POWER CABLE TO CONTACT RAIL

WATERTIGHT SEALING COLLARS

TOP OF PEDESTAL

0


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DETAIL "2" CABLE CONNECTOR ASSEMBLY N.T.S.

10/2007 SCALE



TURNOUT NO.	A	В	c	D
8	8'-0"	23'-0"	t	145'-0"
В	9'-0"	23'-0"	•	180'-0"
10	10'-0"	30'-0"	•	205'-0"
15	10'-0"	58'-0"	٠	280'-0"

(*) SEE DESIGN CRITERIA

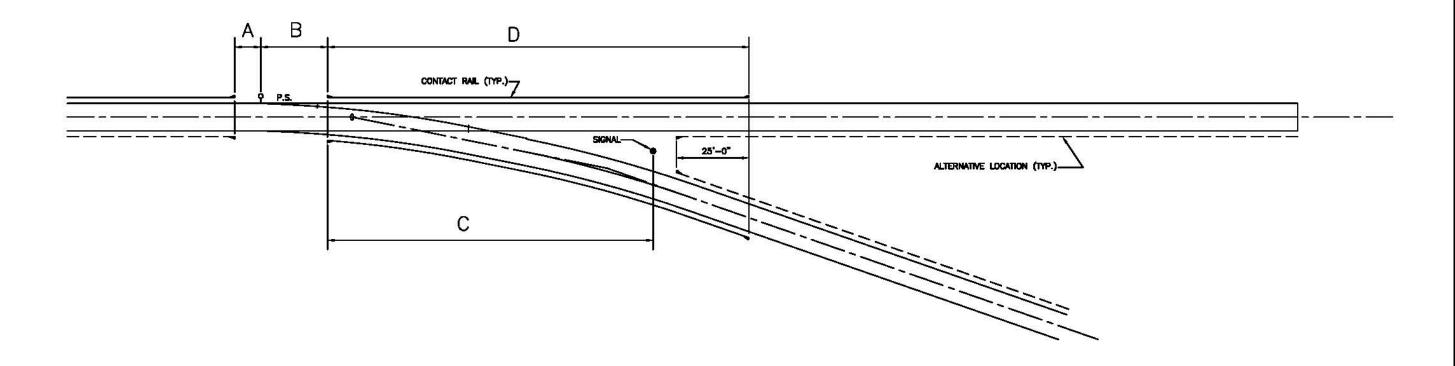NOTES:

- 1. FOR LOCATION AND DETAILS OF CONTACT RAIL CABLE AT TRACKSIDE, ELECTRICAL DD DRAWINGS.
- 2. CONTACT RAIL LAYOUTS/ ARRANGEMENTS MAY VARY FROM CONTACT TO CONTRACT AND SHOULD BE FIELD VERIFIED PRIOR TO ANY PROCUREMENT OR FABRICATION PHASES. DISTANCES SHOWN ARE BASED ON CLEARANCES TO TANGENT DIVERGING TRACK—SEE DESIGN CRITERIA.

	REFERENCE DRAWINGS			REVISIONS			
DESIGNED _B_TMSHM	NUMBER	DESCRIPTION	DATE	BY	DESCRIPTION		
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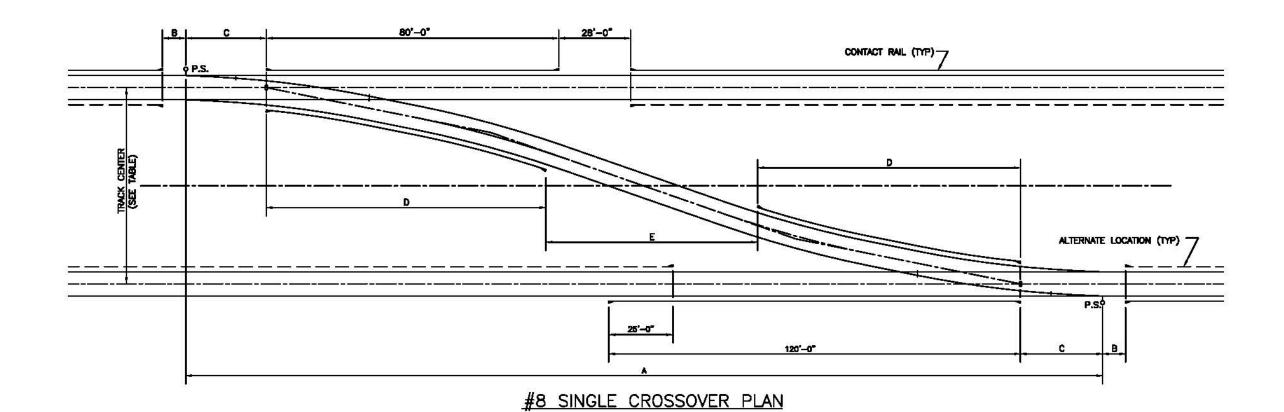
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	OFFICE OF	ENGINEERING	SUPPORT	SERVICES	20100
120 /	11-			1 1	\neg

CONTACT RAIL ARRANGEMENT
NO.6, NO.8, NO.10, NO.15
TURNOUTS

10/2007 SCALE DRAWING NO.
DD—TW—CR—018

CONTACT RAIL DESIGN DRAWING

	-URPadatt		19
SUBMITTED	or neight	10/2007	APPROVED
×		DATE	V




TRACK CENTER	A	В	С	D	E
14"-0"	191.56'	33'-0"	23'-0"	35'-0"	75.56
36'-10"	295.00'	8,-0,	23'-0"	96,-0,	24.00
40'-6°	304.00	33'-0"	23'-0°	129'-0"	0

NOTE:

- FOR LOCATION AND DETAILS OF CONTACT RAIL CABLE AT TRACKSIDE SEE ELECTRICAL DD DRAWINGS.
- CONTRACT RAIL LAYOUTS/ ARRANGEMENTS MAY VARY FROM VERIFIED PRIOR TO CONTRACT TO CONTRACT AND SHOULD ANY PROCUREMENT OR FABRICATION PHASES.

	REFERENCE DRAWINGS	REVISIONS	WASHINGTON METROPOLITAN AREA TRANSIT AUTHORITY	CONTACT RAIL DESIGN DRAWING
DESIGNED	NUMBER DESCRIPTION	DATE BY DESCRIPTION 12/2006 CENF NUMBER REVISIONS	WASHINGTON METROTOLITAN AREA TRANSIT ACTIONITY	CONTACT RAIL ARRANGEMENT
DRAWN A DIME GRADE		69/09 A STORED NOTE NO. 2	OFFICE OF ENGINEERING SUPPORT SERVICES	NO. 8 SINGLE CROSSOVER 14'-0". 36'-10" AND 40'-6" TRACK CENTERS
CHECKED RINCHEFELLER 11/08			- Report to some	14 -U , 30 -IU AND 40 -6 TRACK CENTERS
APPROVED_L_PAGETT			SUBMITTED 10/2007 APPROVED 10/2007	SCALE DRAWING NO. DD-TW-CR-019
			DATE	DD-111-01(-019

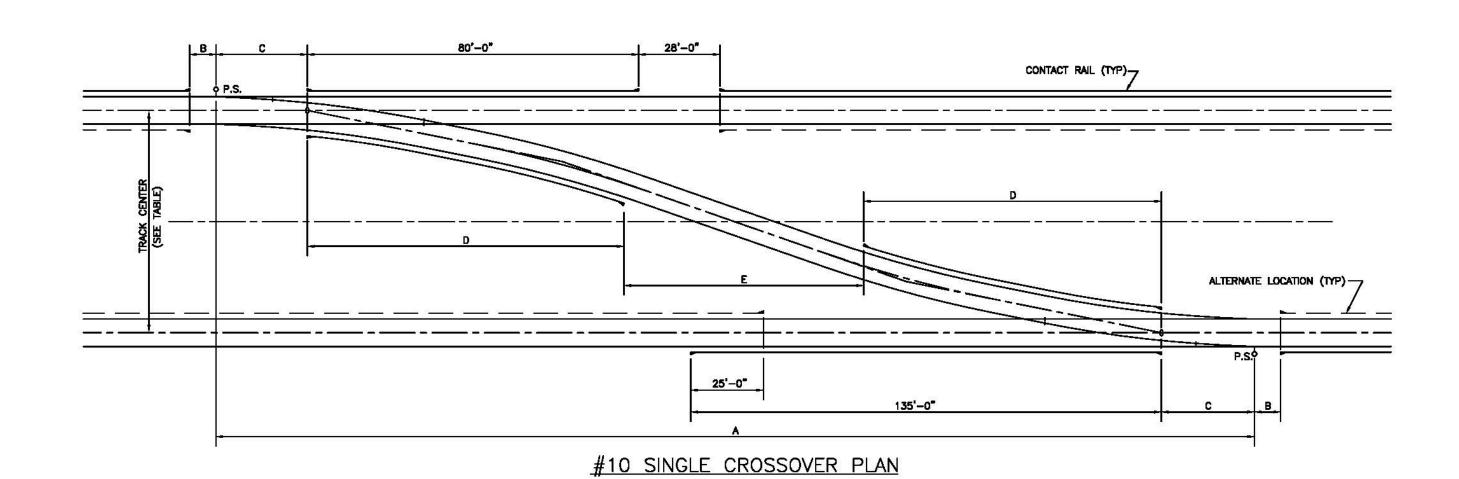


TRACK CENTERS	A	В	С	D	E
14'-0"	202.5'	10"-0"	30'-0"	38'-0"	66.50
36'-10"	352.82'	10'-0"	30'-0"	116'-0"	60.62
40'-6"	369.73	10'-0"	30'-0"	124'-0"	61.73

NOTE:

- 1. FOR LOCATION AND DETAILS OF CONTACT RAIL CABLES AT TRACKSIDE SEE ELETRICAL DD DRAWINGS.
- CONTRACT RAIL LAYOUTS/ ARRANGEMENTS MAY VARY FROM CONTRACT TO CONTRACT AND SHOULD VERIFIED PRIOR TO ANY PROCUREMENT OR FABRICATION PHASES.

	REFERENCE DRAWINGS	REVISIONS	WASHINGTON METROPOLITAN AREA TRANSIT AUTHORITY	CONTACT RAIL DESIGN DRAWING		
DESIGNED <u>IN TRACKAL</u> 10-80.	NUMBER DESCRIPTION	DATE BY DESCRIPTION 12/2006 DEF KINDS NEVISIONS	WASHINGTON METROTOLITAN AREA TRANSIT AUTHORITT	CONTACT RAIL ARRANGEMENT		
DRAWN A DAME 95/00		09/06 A ADRED MITTE NO. 2	OFFICE OF ENGINEERING SUPPORT SERVICES	NO. 10 SINGLE CROSSOVER		
CHECKED RINGGREFELLER 11/08			120 1 tt	14'-0", 36'-10" AND 40'-6" TRACK CENTERS		
APPROVED L PYOPETT 11/06	K K		SUBMITTED -URPACISETY 10/2007 APPROVED 10/2007	SCALE DRAWING NO.		
			DATE	NONE DD-TW-CR-020		

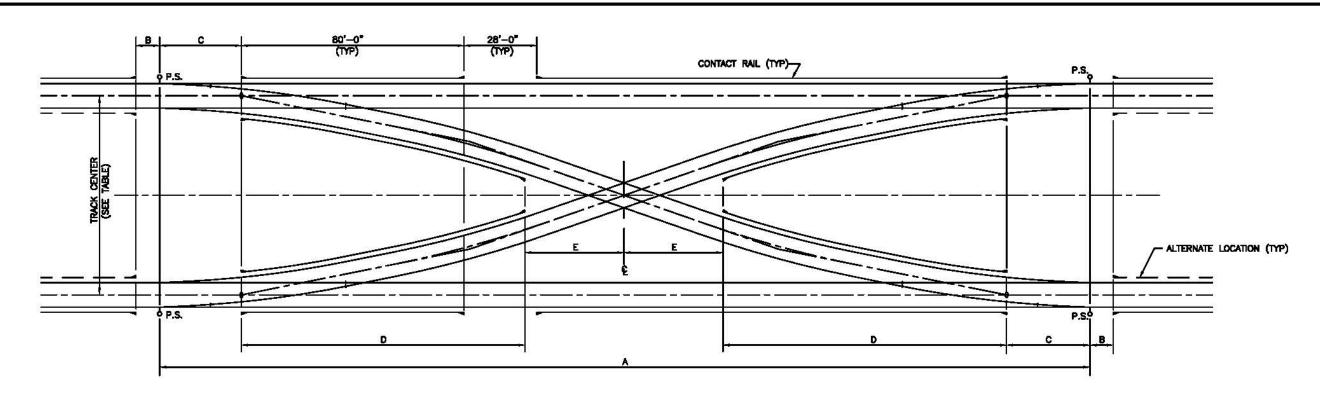

#8 DOUBLE CROSSOVER PLAN

TRACK CENTERS	A	В	C	D	E
14'-0"	174'	19'-0"	23'-0"	18.0'	46"
36'-10"	295'	9,-0,	23'-0"	98.0'	28.5
40'-6"	368'	101'-0"	30'-0"	124.0'	30'

NOTE:

- 1. FOR LOCATION AND DETAILS OF CONTACT RAIL CABLES AT TRACKSIDE SEE ELECTRICAL DD DRAWINGS.
- CONTRACT RAIL LAYOUTS / ARRANGEMENTS MAY VARY FROM CONTRACT TO CONTRACT AND SHOULD VERIFIED PRIOR TO ANY PROCUREMENT OR FABRICATION PHASES.


			REVISIONS			
DESIGNED W. TRRCHAM	NUMBER	DESCRIPTION	DATE	BY	DESCRIPTION	1
	- 5		12/2006	CENT	NINGR GEVISIONS	
DRAWN A DANS DRAW			19/16	8	△ AMES NOTE NO. 2	_
CHECKED RUNCKEFELLER 11/06						_
DOE						4
APPROVED L PROSETT 11/06						4
- 100						4
MORTHS.						

WASHINGTON	METROPOLITAN	AREA	TRANSIT	AUTHORITY
	OFFICE OF ENGINEERING	SUPPORT	SERVICES	
SUBMITTED - URPAdje	10/2007 DATE	APPROVED	pe 1 my	10/2007 DATE

10/2007 SCALE APPROVED

CONTACT RAIL DESIGN DRAWING
CONTACT RAIL ARRANGEMENT
No. 8 DOUBLE CROSSOVER
14'-0". 36'-10" AND 40'-6" TRACK CENTERS

DD-TW-CR-021

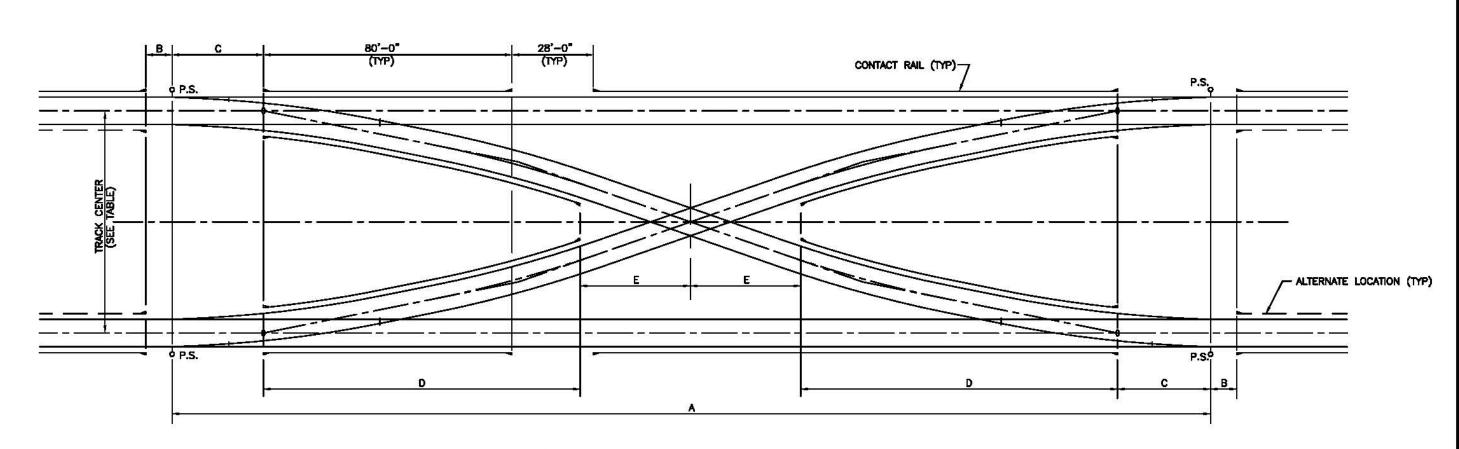

#10 DOUBLE CROSSOVER PLAN

TRACK CENTERS	A	8	С	D	E
14'-0"	202.48'	10'-0"	31'-42"	15.0"	53.5'
36'-10"	352.81	10'-0"	31'-42"	105.0	. 4 1'
40'-6"	369.71	7.625	31'-42"	124.0	30.865


NOTE

- FOR LOCATION AND DETAILS OF CONTACT RAIL CABLES AT TRACKSIDE SEE ELECTRICAL DD DRAWINGS.
- CONTRACT RAIL LAYOUTS/ ARRANGEMENTS MAY VARY FROM CONTRACT TO CONTRACT AND SHOULD VERIFIED PRIOR TO ANY PROCUREMENT OR FABRICATION PHASES.

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DOE								

WASH	HINGTON	METR	ROPO	LITAN	AREA	TRANSIT	AUTHO	RITY	
		OFFICE	OF EN	IGINEERING	SUPPORT	SERVICES	~~		
SUBMITTED	-WPadget	tot	10/20	007	APPROVED	le Am	10	/2007	SCA
-			DAT	E		1		DATE	

(CONTAC	T RAIL DESIGN DRAWING
		TACT RAIL ARRANGEMENT
14'	-0", 36°	. 10 DOUBLE CROSSOVER -10" AND 40'-6" TRACK CENTERS
Ē	NONE	DRAWING NO. DD-TW-CR-022

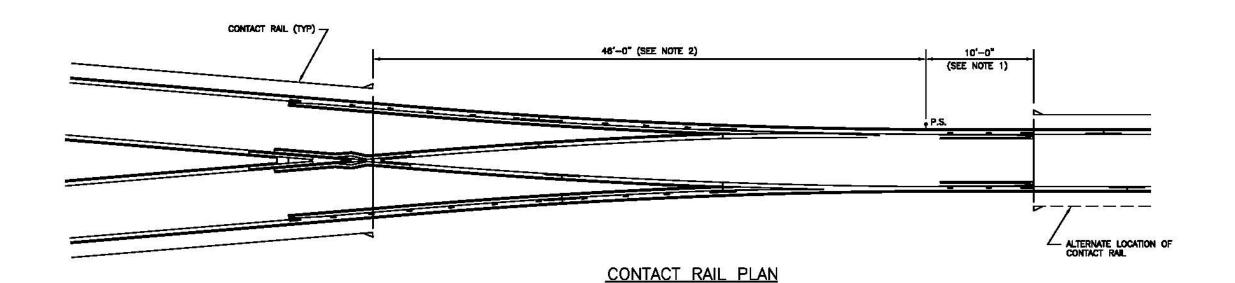

NOTES:

#6 EQUILATERAL TURNOUT

- WHEN DERAIL IS INSTALLED ON THE SAME SIDE OF TRACK AS THE CONTACT RAIL, THIS DIMENSION SHALL BE 23'-0".
- 2. THIS DIMENSION CAN BE REDUCED TO 33'-0° IF THE 10'-0° DIMENSION IS INCREASED, (TOTAL GAP= 56'-0").
- FOR LOCATION AND DETAILS OF CONTACT RAIL CABLES AT TRACKSIDE SEE ELECTRICAL DD DRAWINGS.
- CONTACT RAIL LAYOUTS/ARRANGEMENTS MAY VARY FROM CONTRACT TO CONTRACT AND SHOULD BE VERIFIED PRIOR TO ANY PROCUREMENT OR FABRICATION PHASES.

	REFERENCE DRAWINGS			REVISIONS		
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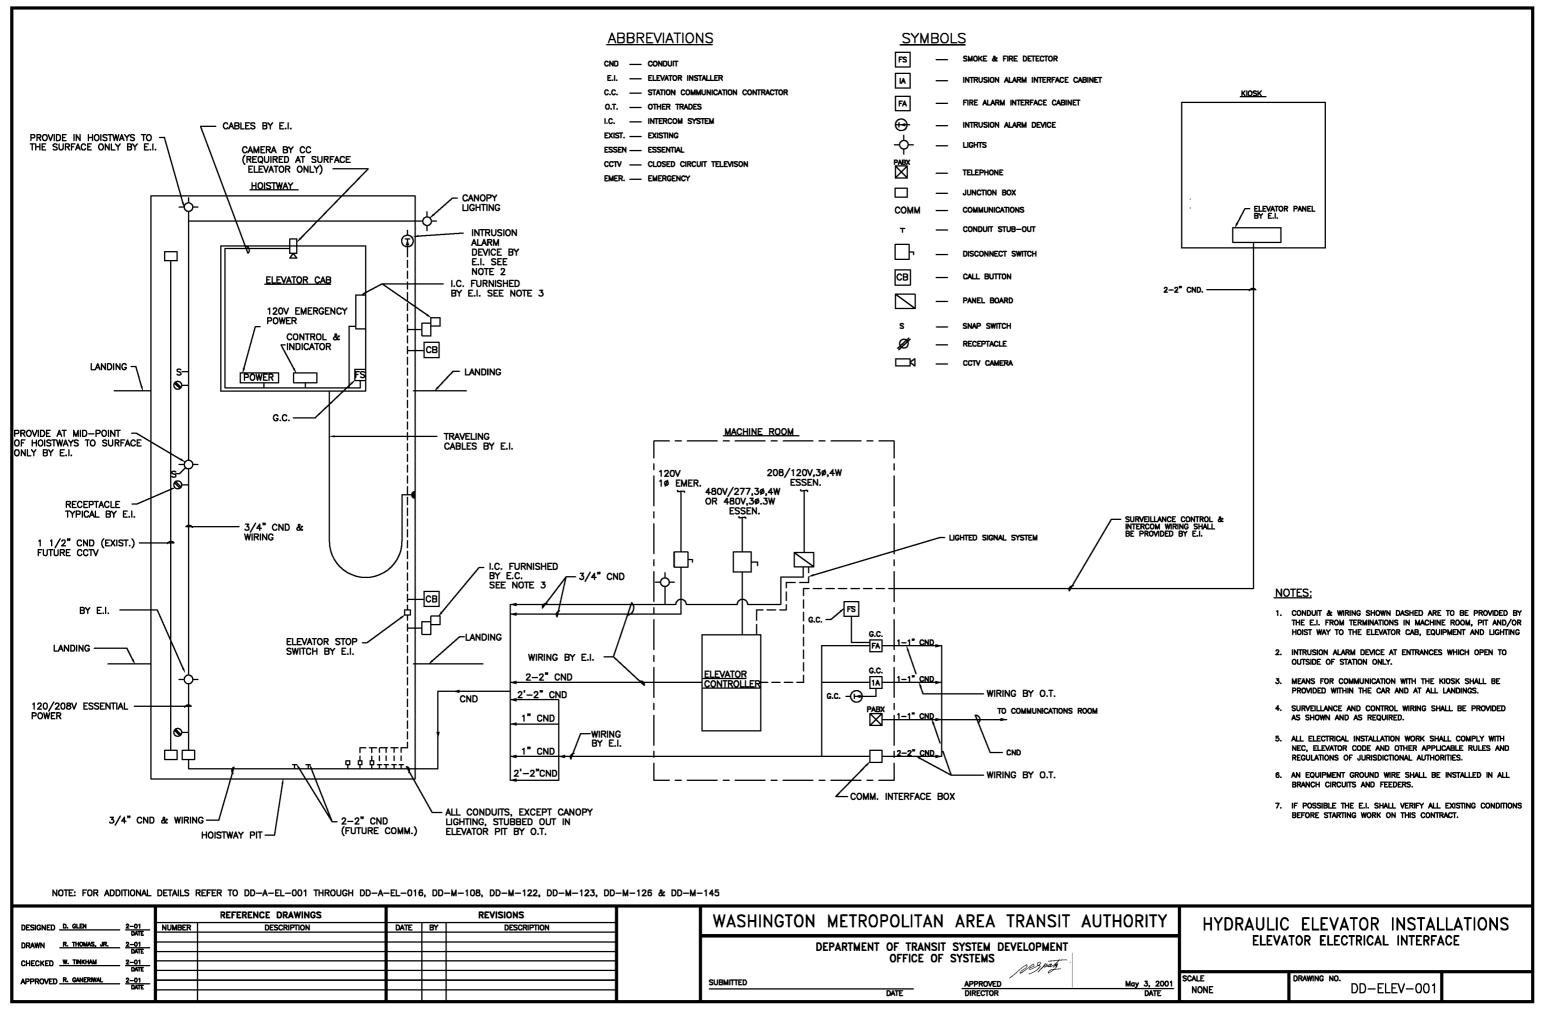
WASHINGTON	METROPOLITAN	AREA	TRANSIT	AUTHORITY
	OFFICE OF ENGINEERING	SUPPORT	SERVICES	2008


SUBMITTED -URPadsett 10/2007
DATE

APPROVED APPROVED

CONTRACT RAIL DESIGN DRAWING CONTACT RAIL ARRANGEMENT No.6 EQUILATERAL TURNOUT

10/2007 SCALE 1/4" = 1'-0" DRAWING NO.
1 0 1 2 3 4 5 DD-TW-CR-023



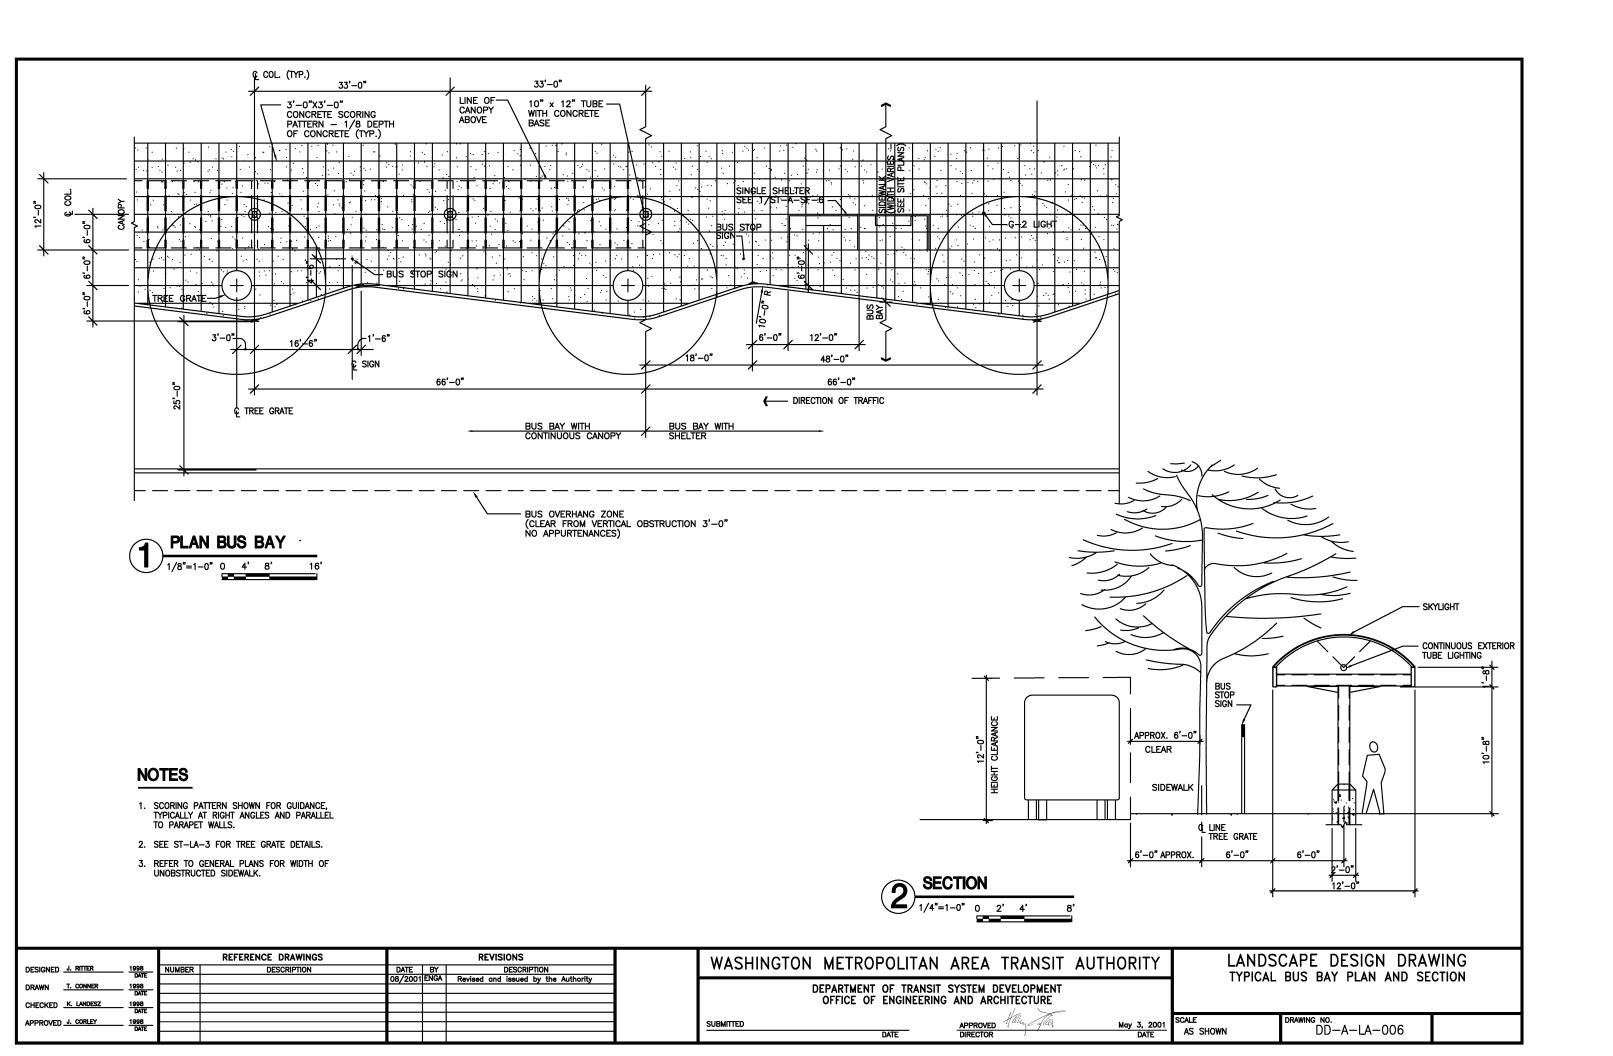

PLANT & MATERIALS KEY **PLANT LIST** EXISTING DECIDUOUS NEW EVERGREEN SHADE TREE HEDGE BOTANICAL NAME: MIN. PIT SIZE HEIGHT MIN. DEPTH MIN. DIA. REMARKS ROOT COMMON NAME (DIA. x DEPTH) CALIPER RANGE SPREAD OF BALL OF BALL NEW DECIDUOUS **NEW DECIDUOUS** HEDGE SHADE TREE MULCH AREA **NEW DECIDUOUS** (TO BE NOTED) \oplus SHADE TREE IN TREE GRATE PLANTING MIXTURE (TO BE NOTED) DECIDUOUS SHADE TREE PEA GRAVEL (TO BE NOTED) **NEW CONIFEROUS** EVERGREEN TREE NEW MINOR, UPRIGHT SAND (TO BE NOTED) CONIFEROUS EVERGREEN TREES NEW BROADLEAF EVERGREEN TREE CRUSHED STONE (TO BE NOTED) NEW DECIDUOUS FLOWERING TREE CONCRETE PAVING NEW LARGE DECIDUOUS SHRUBS EXISTING GRASS NEW DECIDUOUS SHRUB BED NEW EVERGREEN **SYMBOLS ABBREVIATIONS** — CENTER LINE OF TRACK BALLED & BURLAPPED MIN. MINIMUM — PROPERTY LINE/R.O.W. Base line N.I.C. NOT IN CONTRACT CURB CALIPER O.B.T. OUTBOUND TRACK BUS PASSENGER SHELTER CENTER LINE 0.C. ON CENTER CATCH BASIN CONTAINER OUTSIDE DIAMETER 0.D. \bowtie LIGHT FIXTURE DIAMETER R.O.W. RIGHT-0F-WAY BOLLARD EASTBOUND LANE SPD SPREAD → ★ → DIMENSION/DIRECTION POINT GALLON TYPICAL - - - PEDESTRIAN BARRIER RAIL → → DRAINAGE FLOW/ SWALE I.B.T. INBOUND TRACK W.B.L. WESTBOUND LANE NUMBER MAX. MAXIMUM —- FENCE SIGN ON POST NOTE: 1. ALL PLANT MATERIAL IS TO CONFORM TO AMERICAN STANDARD FOR NURSERY STOCK, ANSI Z60.1, CURRENT EDITION. 2. FOR A COMPLETE LIST OF PLANT AND MATERIALS KEY, SEE DRAWING DD-LA-1. REFERENCE DRAWINGS REVISIONS WASHINGTON METROPOLITAN AREA TRANSIT AUTHORITY LANDSCAPE DESIGN DRAWING DESIGNED D.MUNSON 1998 DATE DATE BY DESCRIPTION 08/2001 ENGA Revised and issued by the Authority PLANT LIST DRAWN W. SCOTT 1998 DEPARTMENT OF TRANSIT SYSTEM DEVELOPMENT OFFICE OF ENGINEERING AND ARCHITECTURE

SUBMITTED


DATE


DD-A-LA-005


SCALE


May 3, 2001 DATE

CHECKED A. DICKINSON 1998

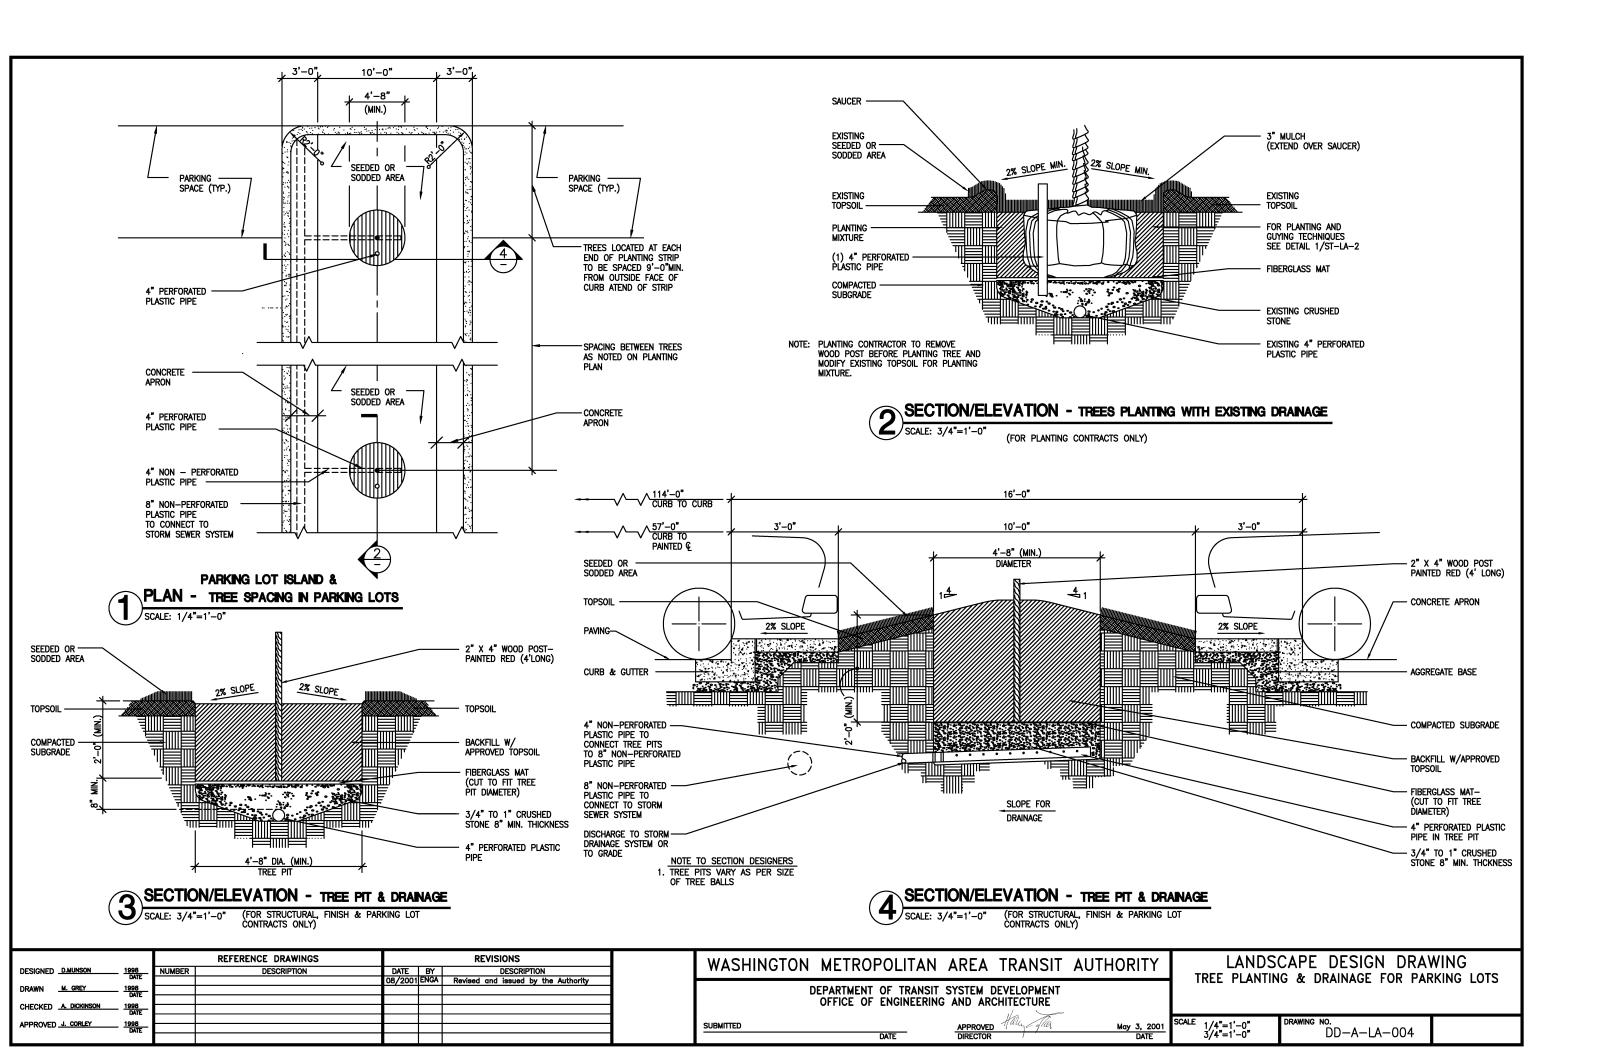

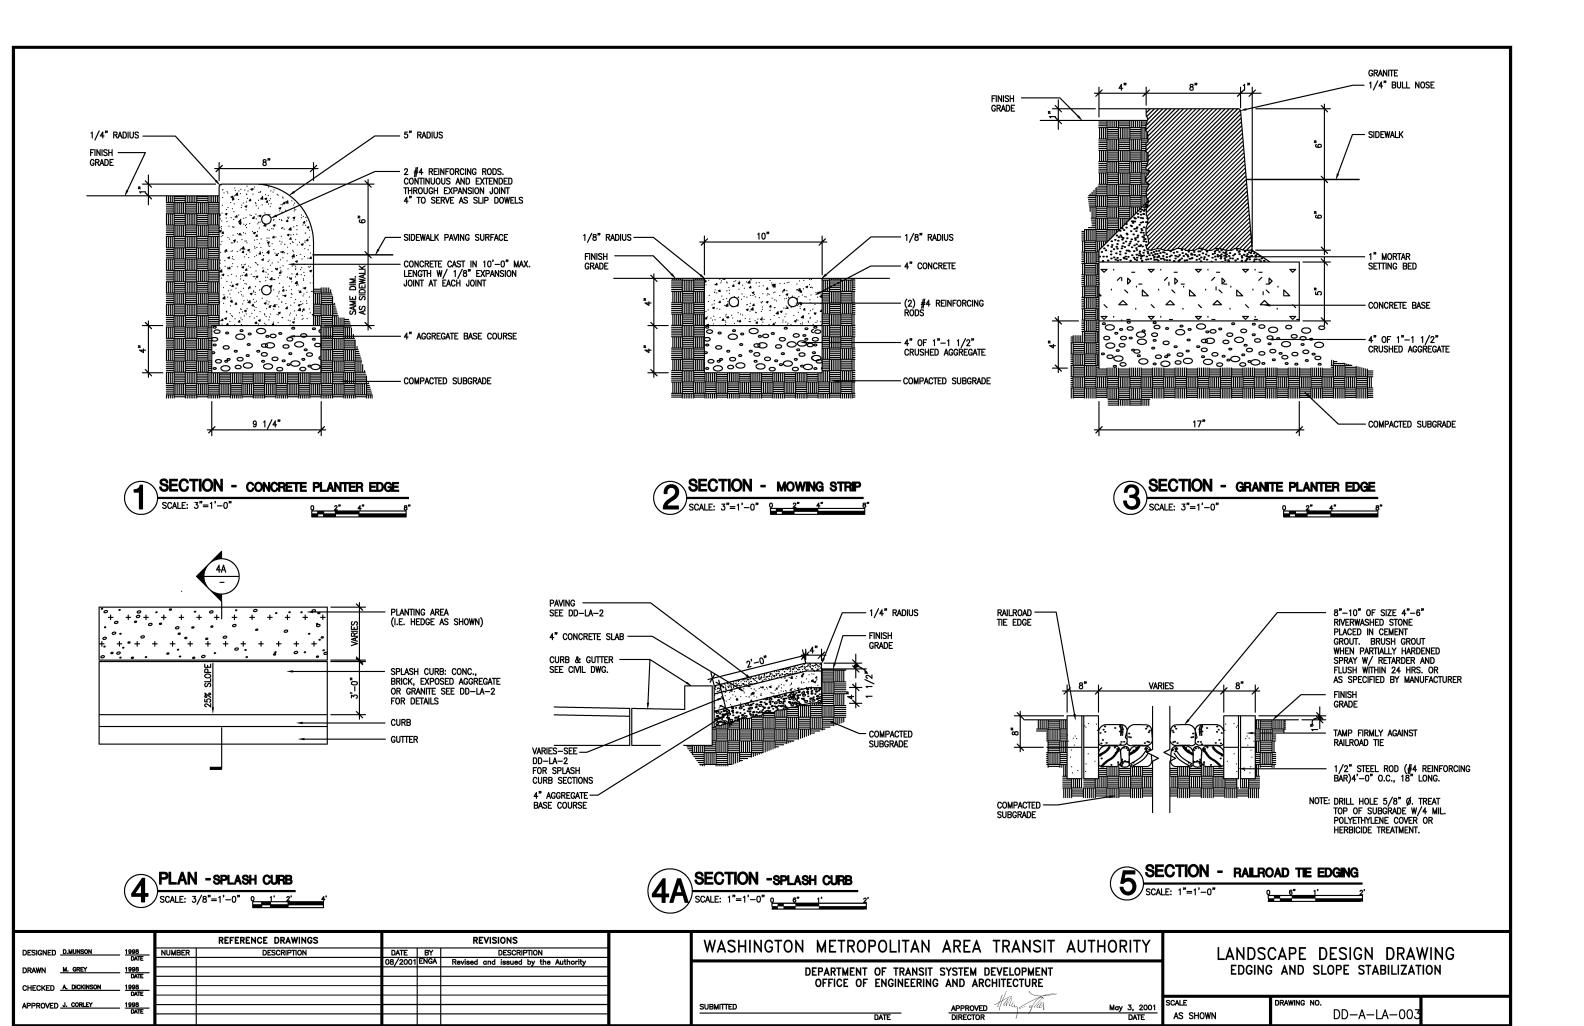

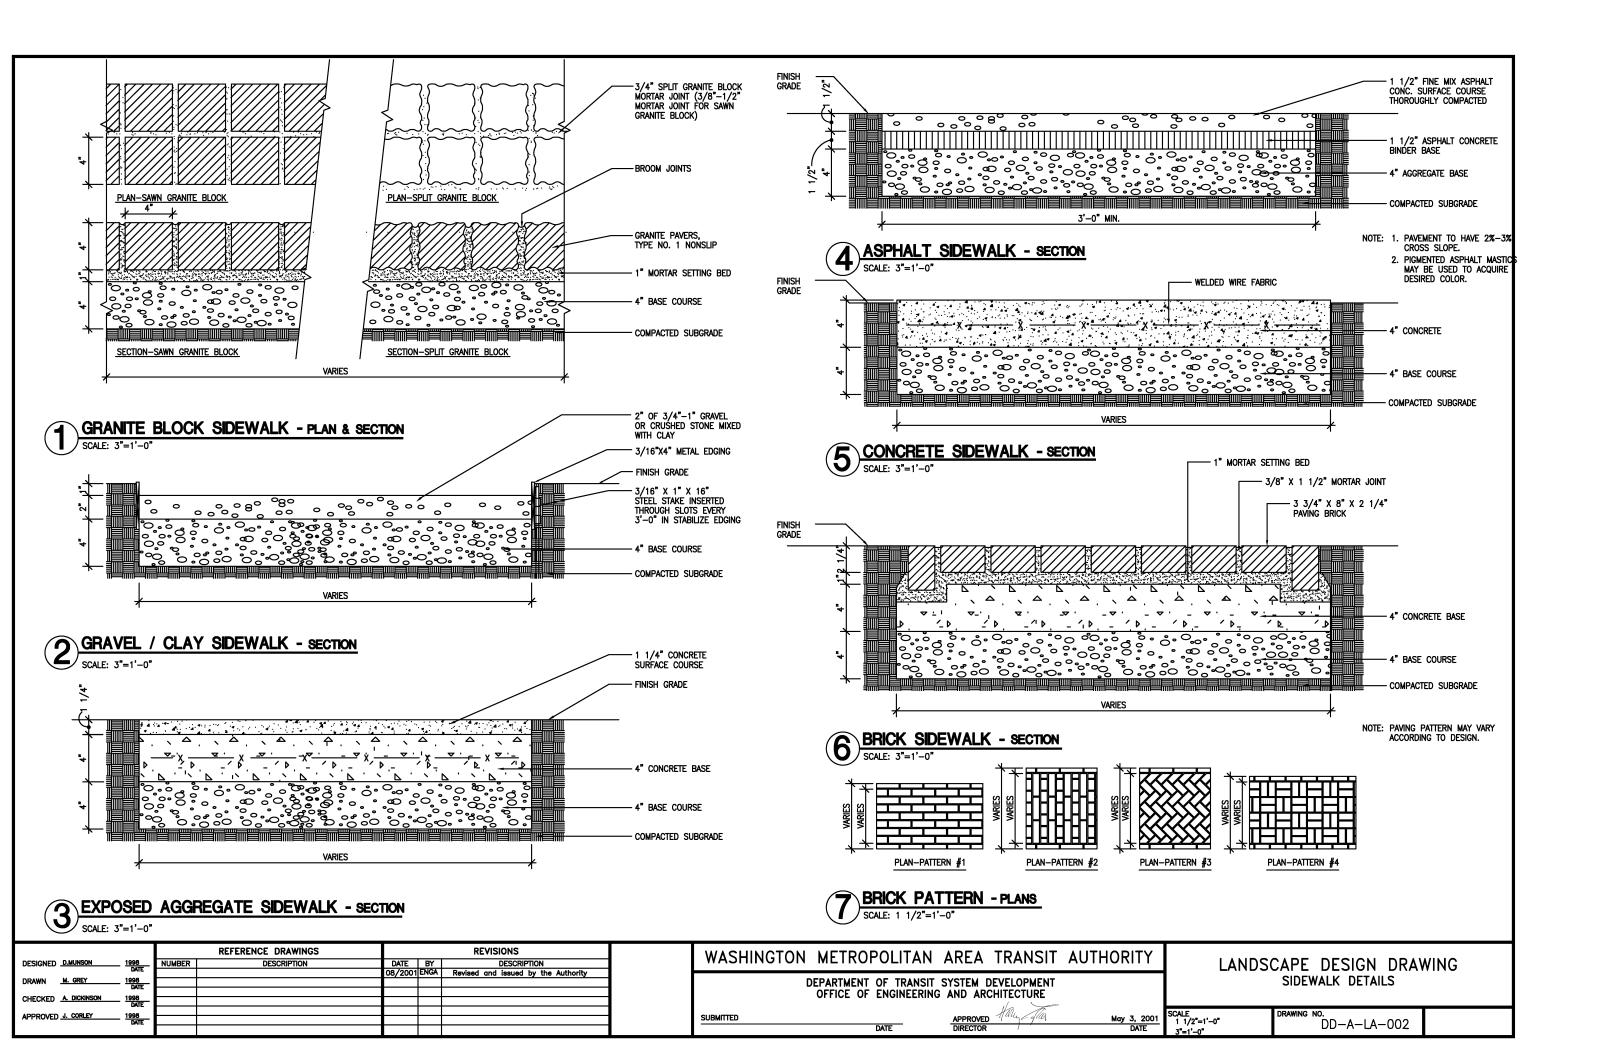

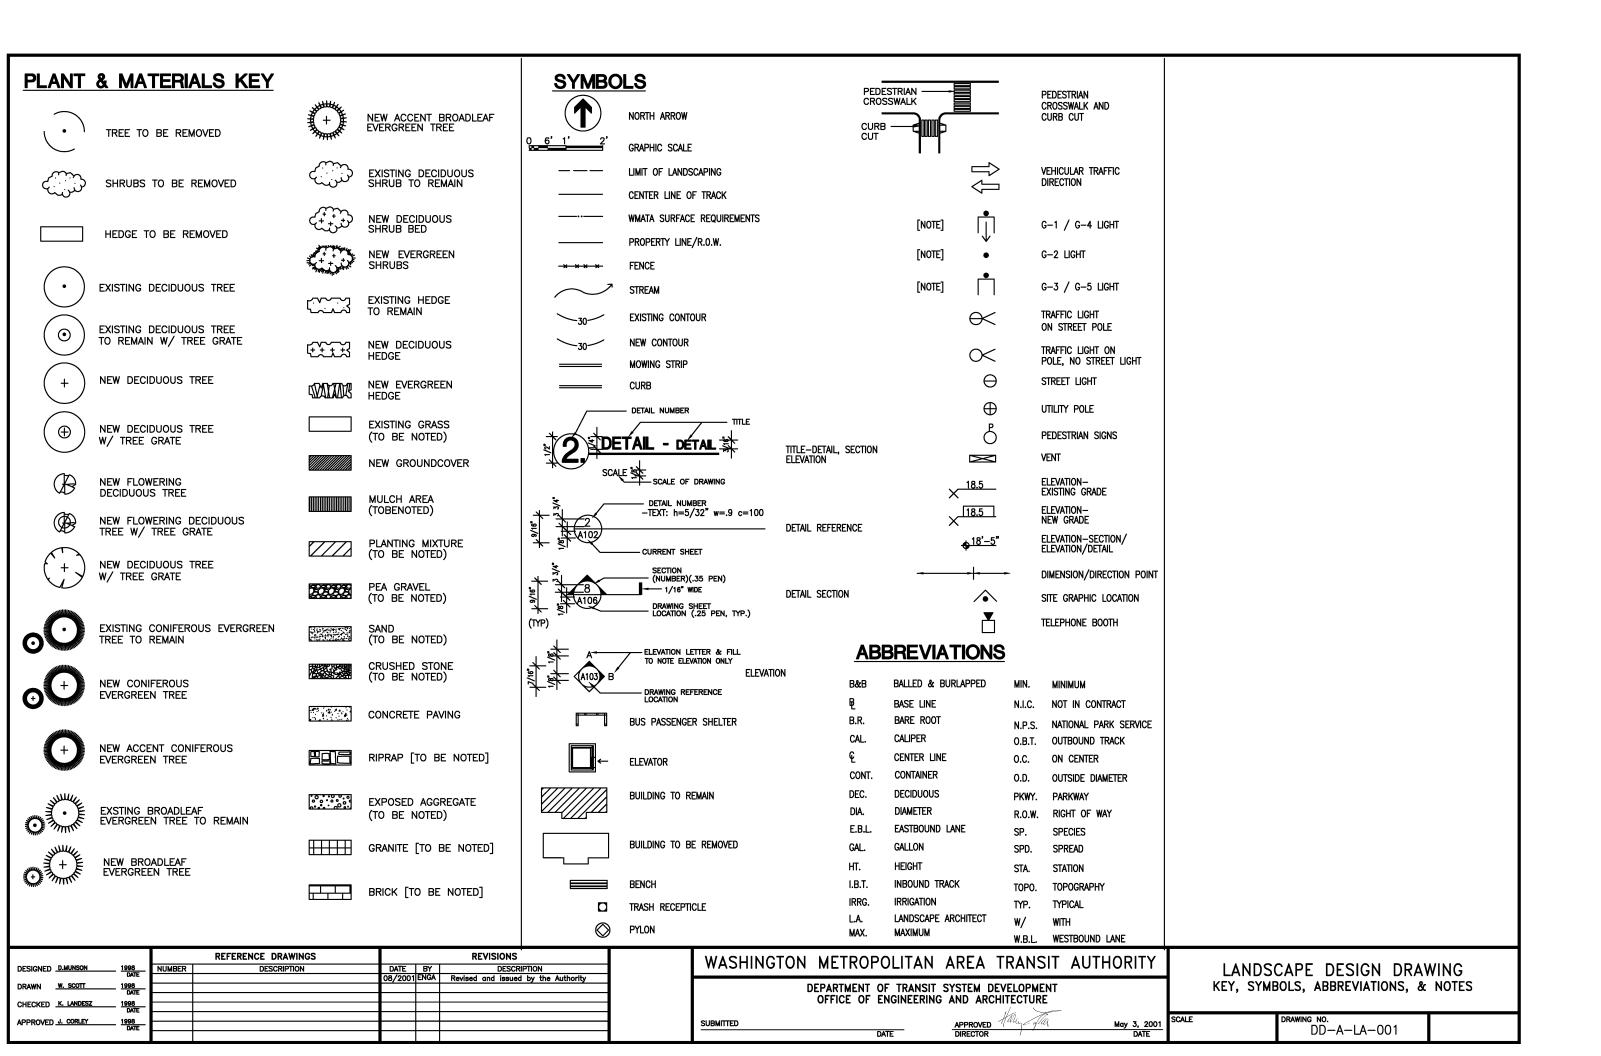

45'-0" COL. (TYP.) 30'-0" 30'-0" 3'-0"X3'-0" CONCRETE SCORING PATTERN -1/8 DEPTH OF CONCRE 10"X12" TUBE W/CONC. BASE GROOVE - 1/3 DEPTH LINE OF 12'-0" CANOPY 60' ARTICULATED BUS 22'-9" 67'-3" FOR STANDARD BUS BAYS, SEE DWG. DD-LA-6 ← DIRECTION OF TRAFFIC 90'-0" BUS BAY WITH CONTINUOUS CANOPY ¢ TREE GRATE (TYP.) BUS OVERHANG ZONE (CLEAR FROM VERTICAL OBSTRUCTION 3'-0" NO APPURTENANCES) PLAN ARTICULATED BUS BAY SKYLIGHT 59'-7 7/8" 26'-2 1/4" 33'-5 5/8" 3'-10 1/8"-21'-1 3/4" 2'-8 5/8" 27'-4 1/8" 10'-3-3/4" 리 ∠APPROX. 6'-0" CLEAR SIDEWALK 6'-9 1/2" 1 TREE GRATE 23'-11 3/8 18'-6 3/8" 8'-8 3/8" -0",6'-0" APPROX. 6'-0" 6'-0" ANGLE OF DEPARTURE BREAK OVER ANGLE ANGLE OF APPROACH 12'-0" **ELEVATION** 1/4"=1'-0" 0 2' 4' **REVISIONS** LANDSCAPE DESIGN DRAWING WASHINGTON METROPOLITAN AREA TRANSIT AUTHORITY TYPICAL ARTICULATED BUS BAY DEPARTMENT OF TRANSIT SYSTEM DEVELOPMENT PLAN AND ELEVATION OFFICE OF ENGINEERING AND ARCHITECTURE DRAWING NO. DD-A-LA-007 SCALE May 3, 2001 DATE AS SHOWN

NOTES

SCORING PATTERN SHOWN FOR GUIDANCE, AND IS TYPICALLY AT RIGHT ANGLES AND PARALLEL TO PARAPET WALLS.

PROVIDE DRAINAGE FOR TREES AT BUS BAYS. SEE DD-LA-4 FOR DETAILS.

8'-5 3/4"

REFERENCE DRAWINGS

CHECKED K. LANDESZ

APPROVED J. CORLEY

1998 DATE

2. SEE ST-LA-3 FOR TREE GRATE DETAILS.

4. REFER TO GENERAL PLANS FOR WIDTH OF UNOBSTRUCTED SIDEWALK.

5. BUS DATA BASED ON MAN TRUCK & BUS CORPORATION MODEL SG-310-USA.